


1C DEMO FLOOR PLAN 1/4" = 1'-0"





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GEN. NOTES - DEMO PLAN

1. DASHED LINES ON DEMOLITION DRAWINGS INDICATE EXISTING ITEMS TO BE REMOVED. DRAWINGS ARE DIAGRAMMATIC AND DO NOT SHOW EVERY CONDITION, CONNECTION AND DETAIL. ALL OTHER DEVICES, MATERIALS AND ACCESSORIES NOT SPECIFICALLY DESCRIBED OR CALLED FOR, BUT WHICH ARE REQUIRED FOR A COMPLETE AND FINISHED INSTALLATION FOR THE WORK, SHALL BE FURNISHED AND INSTALLED BY THE CONTRACTOR.
2. WEATHERPROOF ALL EXTERIOR OPENINGS CUT IN DURING DEMOLITION.
3. FOR SIZE AND LOCATION OF ALL NEW OPENINGS FOR NEW DOORS & WINDOWS SEE ARCHITECTURAL DRAWINGS.
4. COORDINATE THE REMOVAL OF ALL STRUCTURAL ELEMENTS W/ ARCHITECTURAL AND STRUCTURAL DRAWINGS.
5. PLANS MAY BE ROTATED FOR CLARITY. REFER TO NORTH ARROWS FOR ACTUAL ORIENTATION.
6. PROTECT ALL EXISTING TO REMAIN.
7. PRIOR TO DEMOLITION, LOCATE, IDENTIFY, STUB OFF, AND DISCONNECT UTILITY SERVICES THAT ARE NOT INDICATED TO REMAIN.

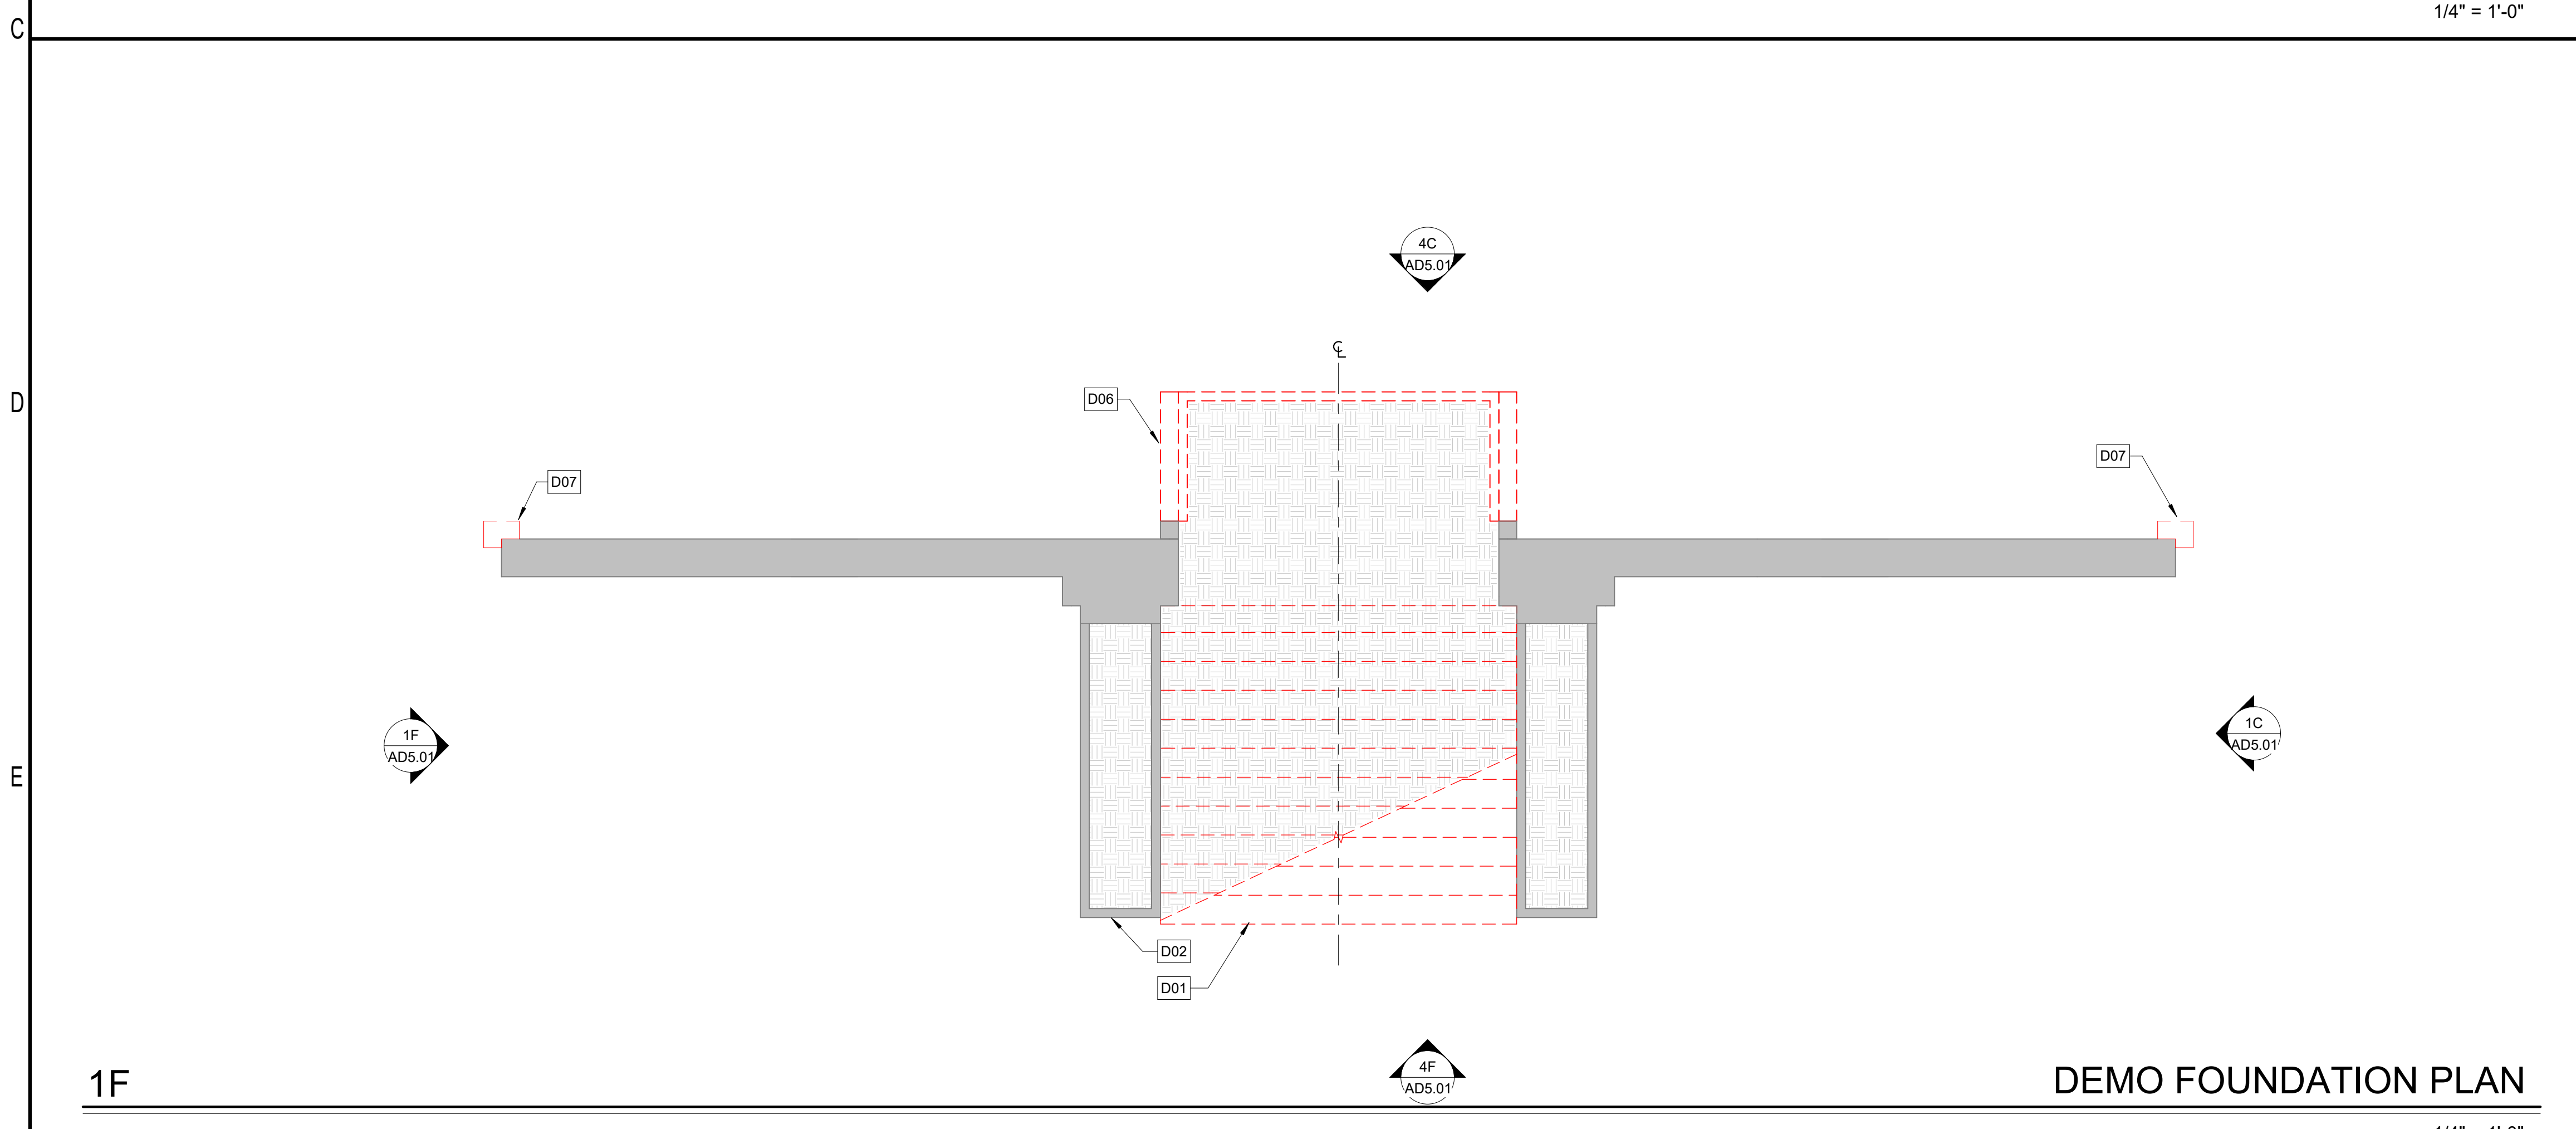

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KEYED NOTES - DEMO

- D01 DEMO EXISTING CONCRETE STAIR AND MTL. HANDRAIL. SHORE/BRACE ADJACENT MASONRY WALL AS REQUIRED TO PREVENT DAMAGE
- D02 PROTECT MASONRY WALL BELOW. SEE REPAIR SHEETS FOR MASONRY WALL TREATMENT
- D03 REMOVE EXISTING LIMESTONE LEDGE CAP FOR REFINISHING. RESET IN ORIGINAL LOCATION ON MASONRY WALLS
- D04 EXISTING MASONRY WALL & LIMESTONE SURROUND. PROTECT IN PLACE. PROVIDE SHORING WHERE NECESSARY FOR LANDING DEMO
- D05 LIMESTONE ARCH OVERHEAD. PROTECT IN PLACE. SEE REPAIR SHEETS FOR SCOPE
- D06 DEMO EXISTING CONCRETE LANDING AND BEARING WALLS BELOW
- D07 DEMO EXISTING MASONRY WALL. PROTECT ADJACENT STRUCTURE AS REQUIRED DURING DEMO
- D08 EXISTING LIMESTONE MASONRY. REPAIR AS PRESCRIBED PER REPAIR SHEETS
- D09 EXISTING MASONRY WING WALL TO REMAIN. CLEAN AND REPAIR TOP COURSE FOR NEW CONCRETE LEDGE CAP
- D10 REMOVE PORTION OF EXISTING MASONRY AT END OF WALL IN PREPARATION FOR NEW END WALL MASONRY. SEE CONSTRUCTION PLANS FOR NEW WALL NOTES

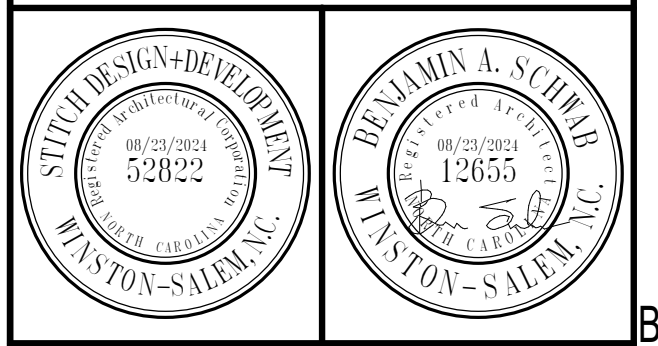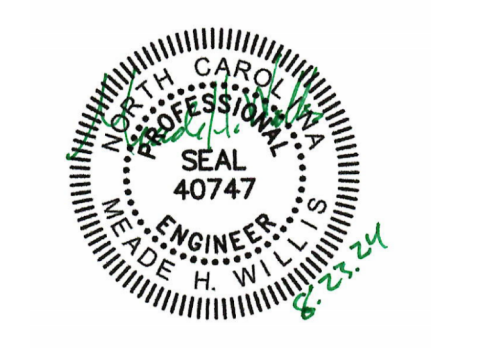PLAN LEGEND

- EXISTING WALL
- DEMOLISHED WALL

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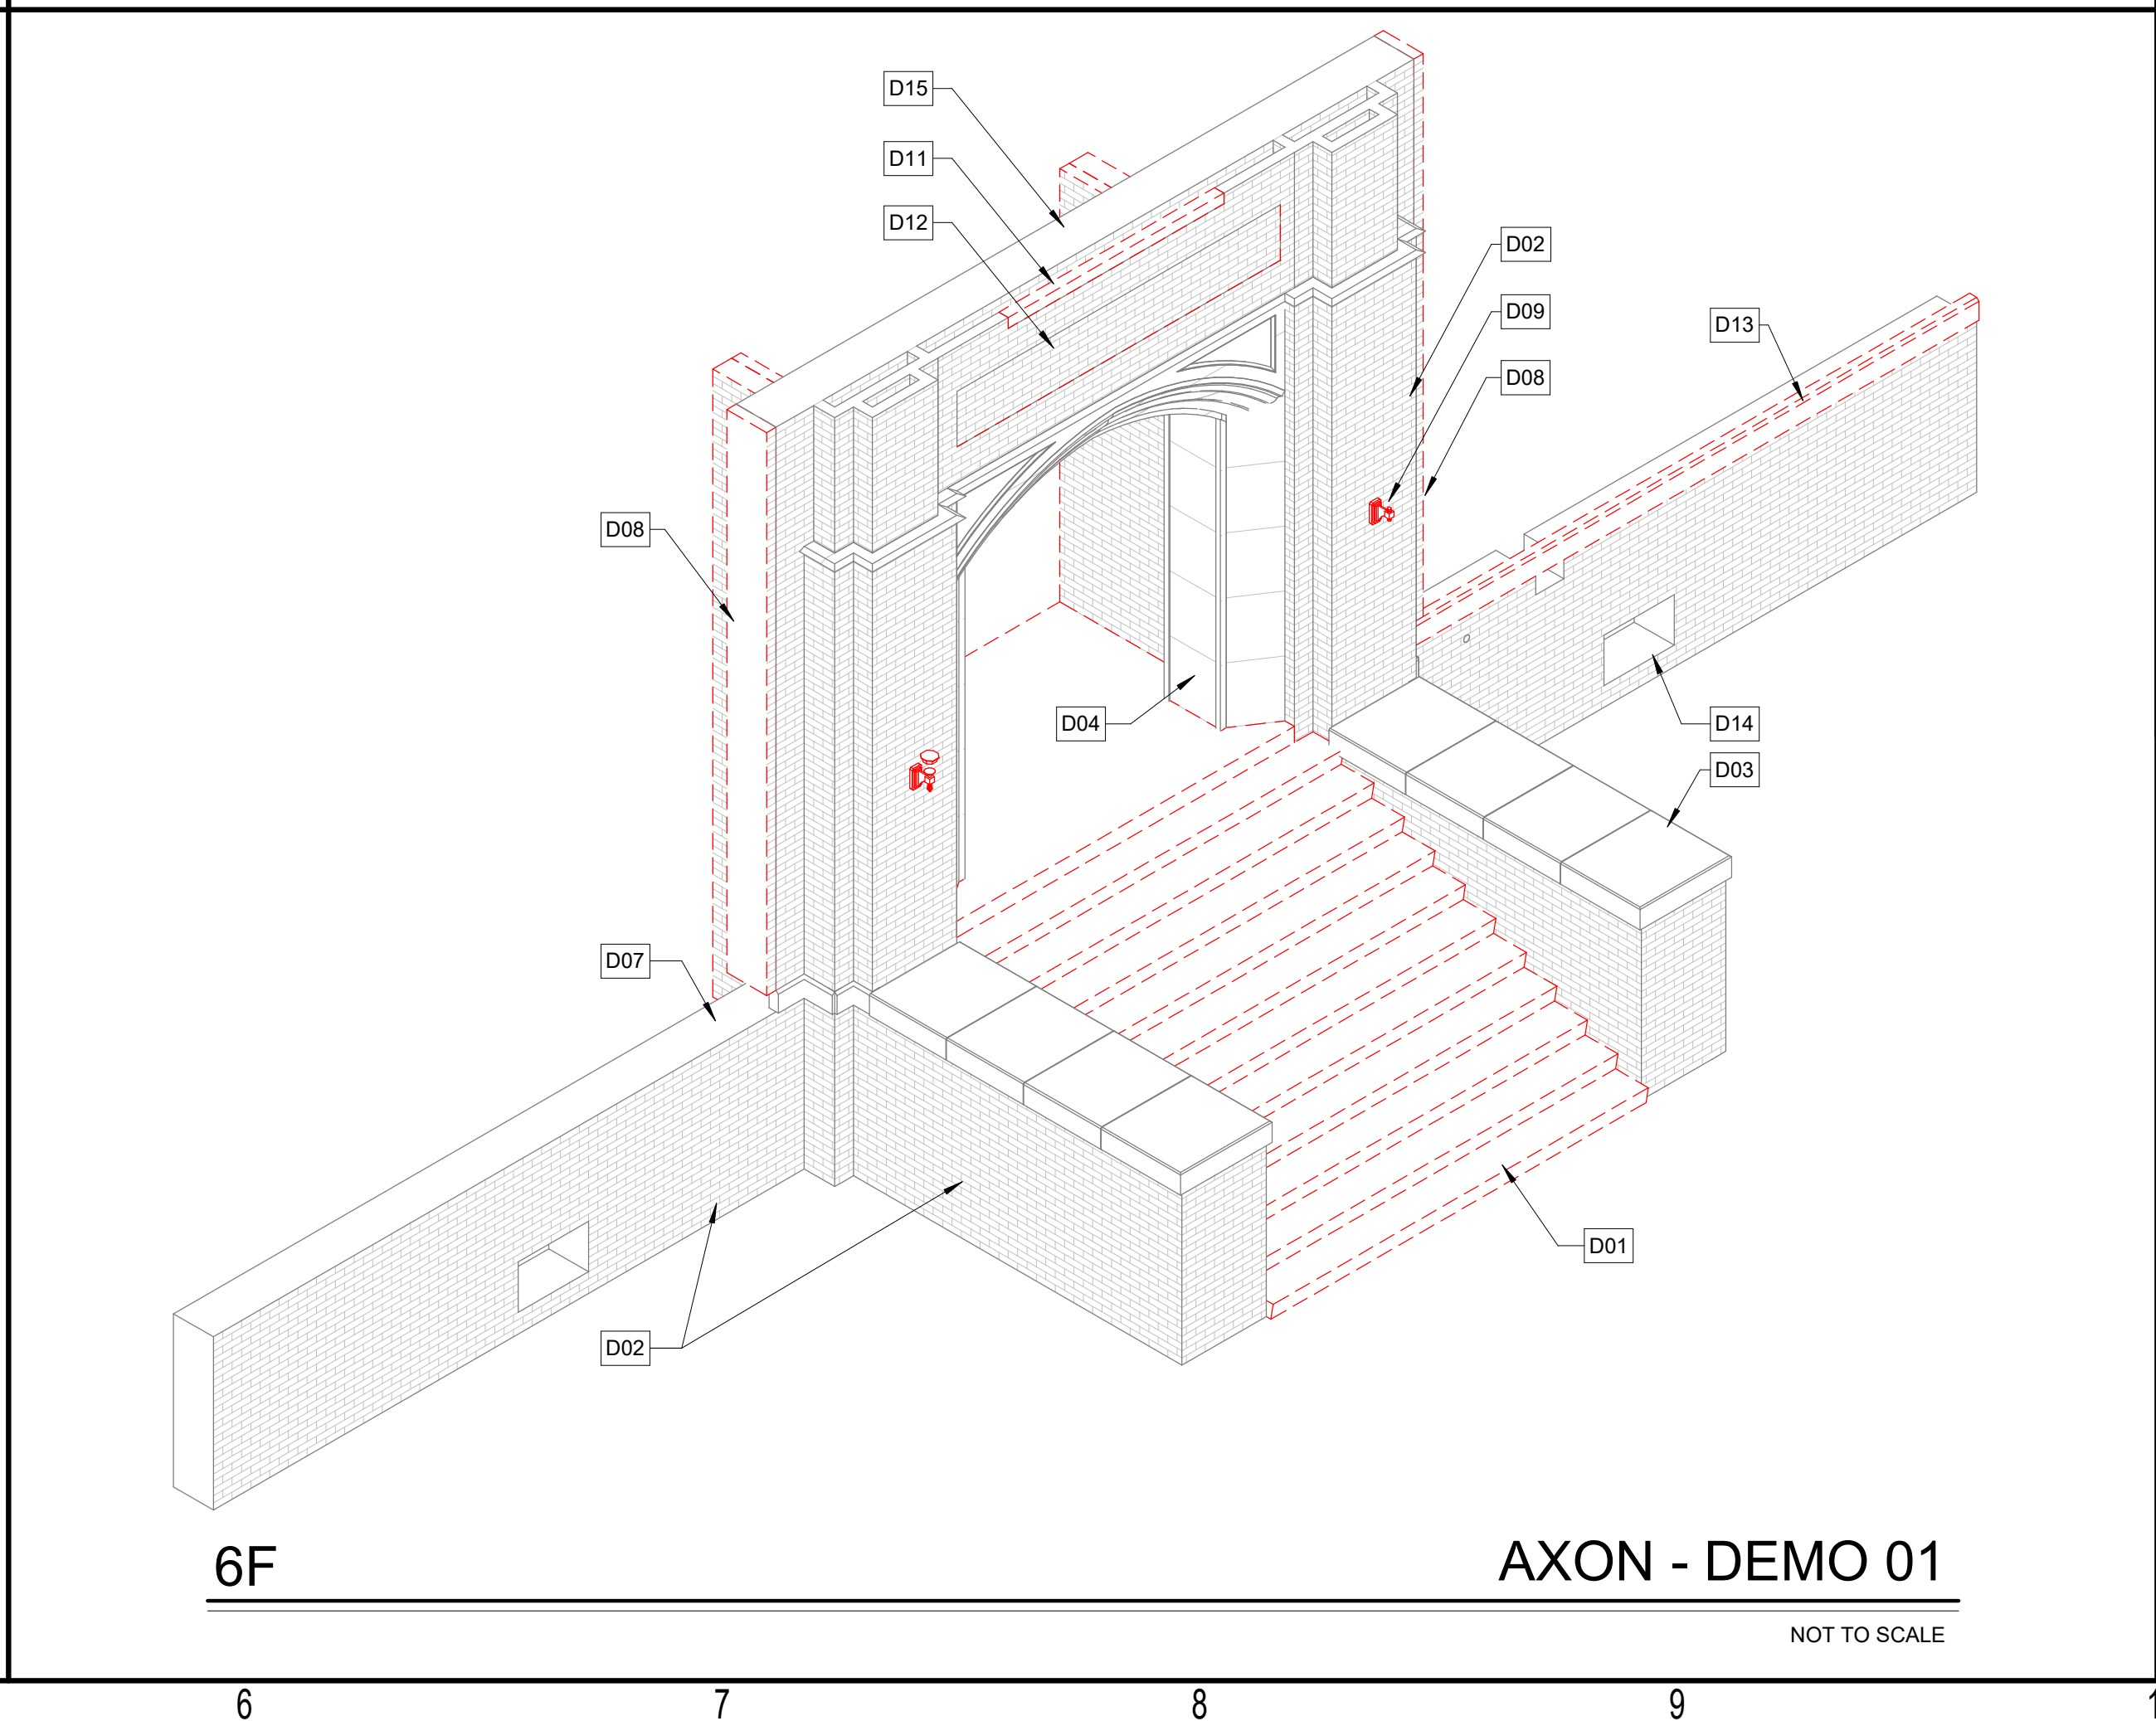
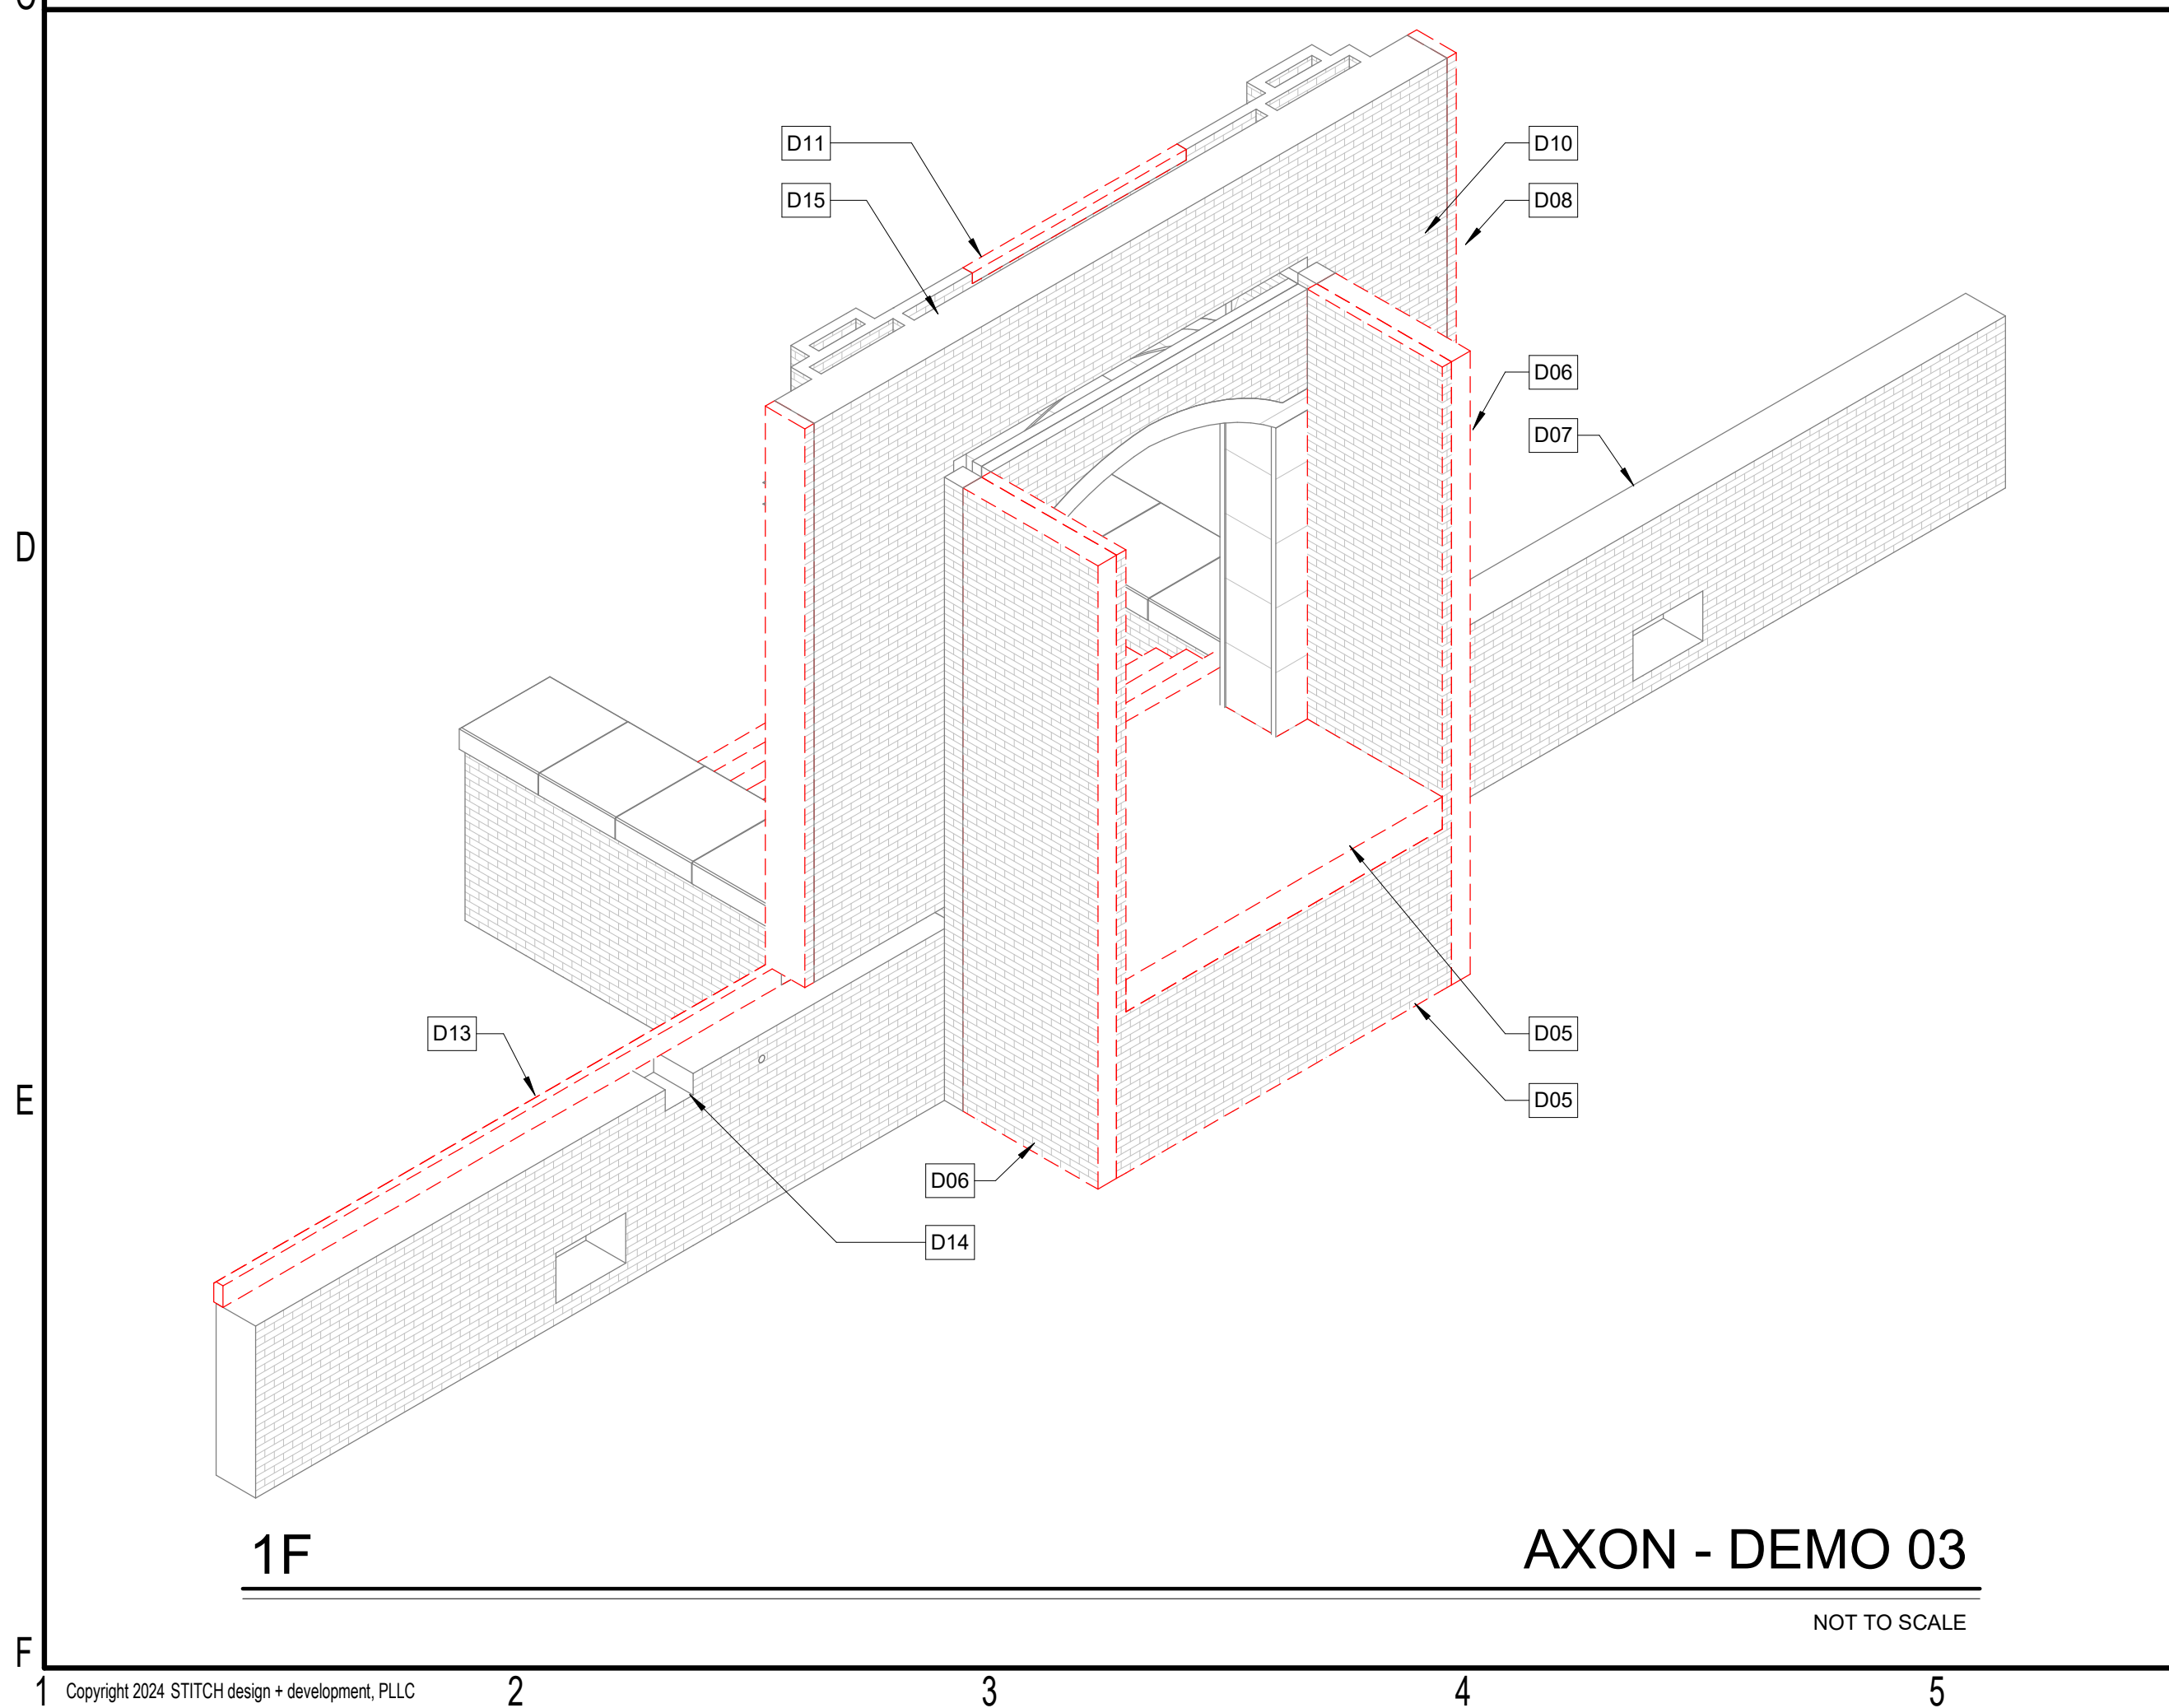
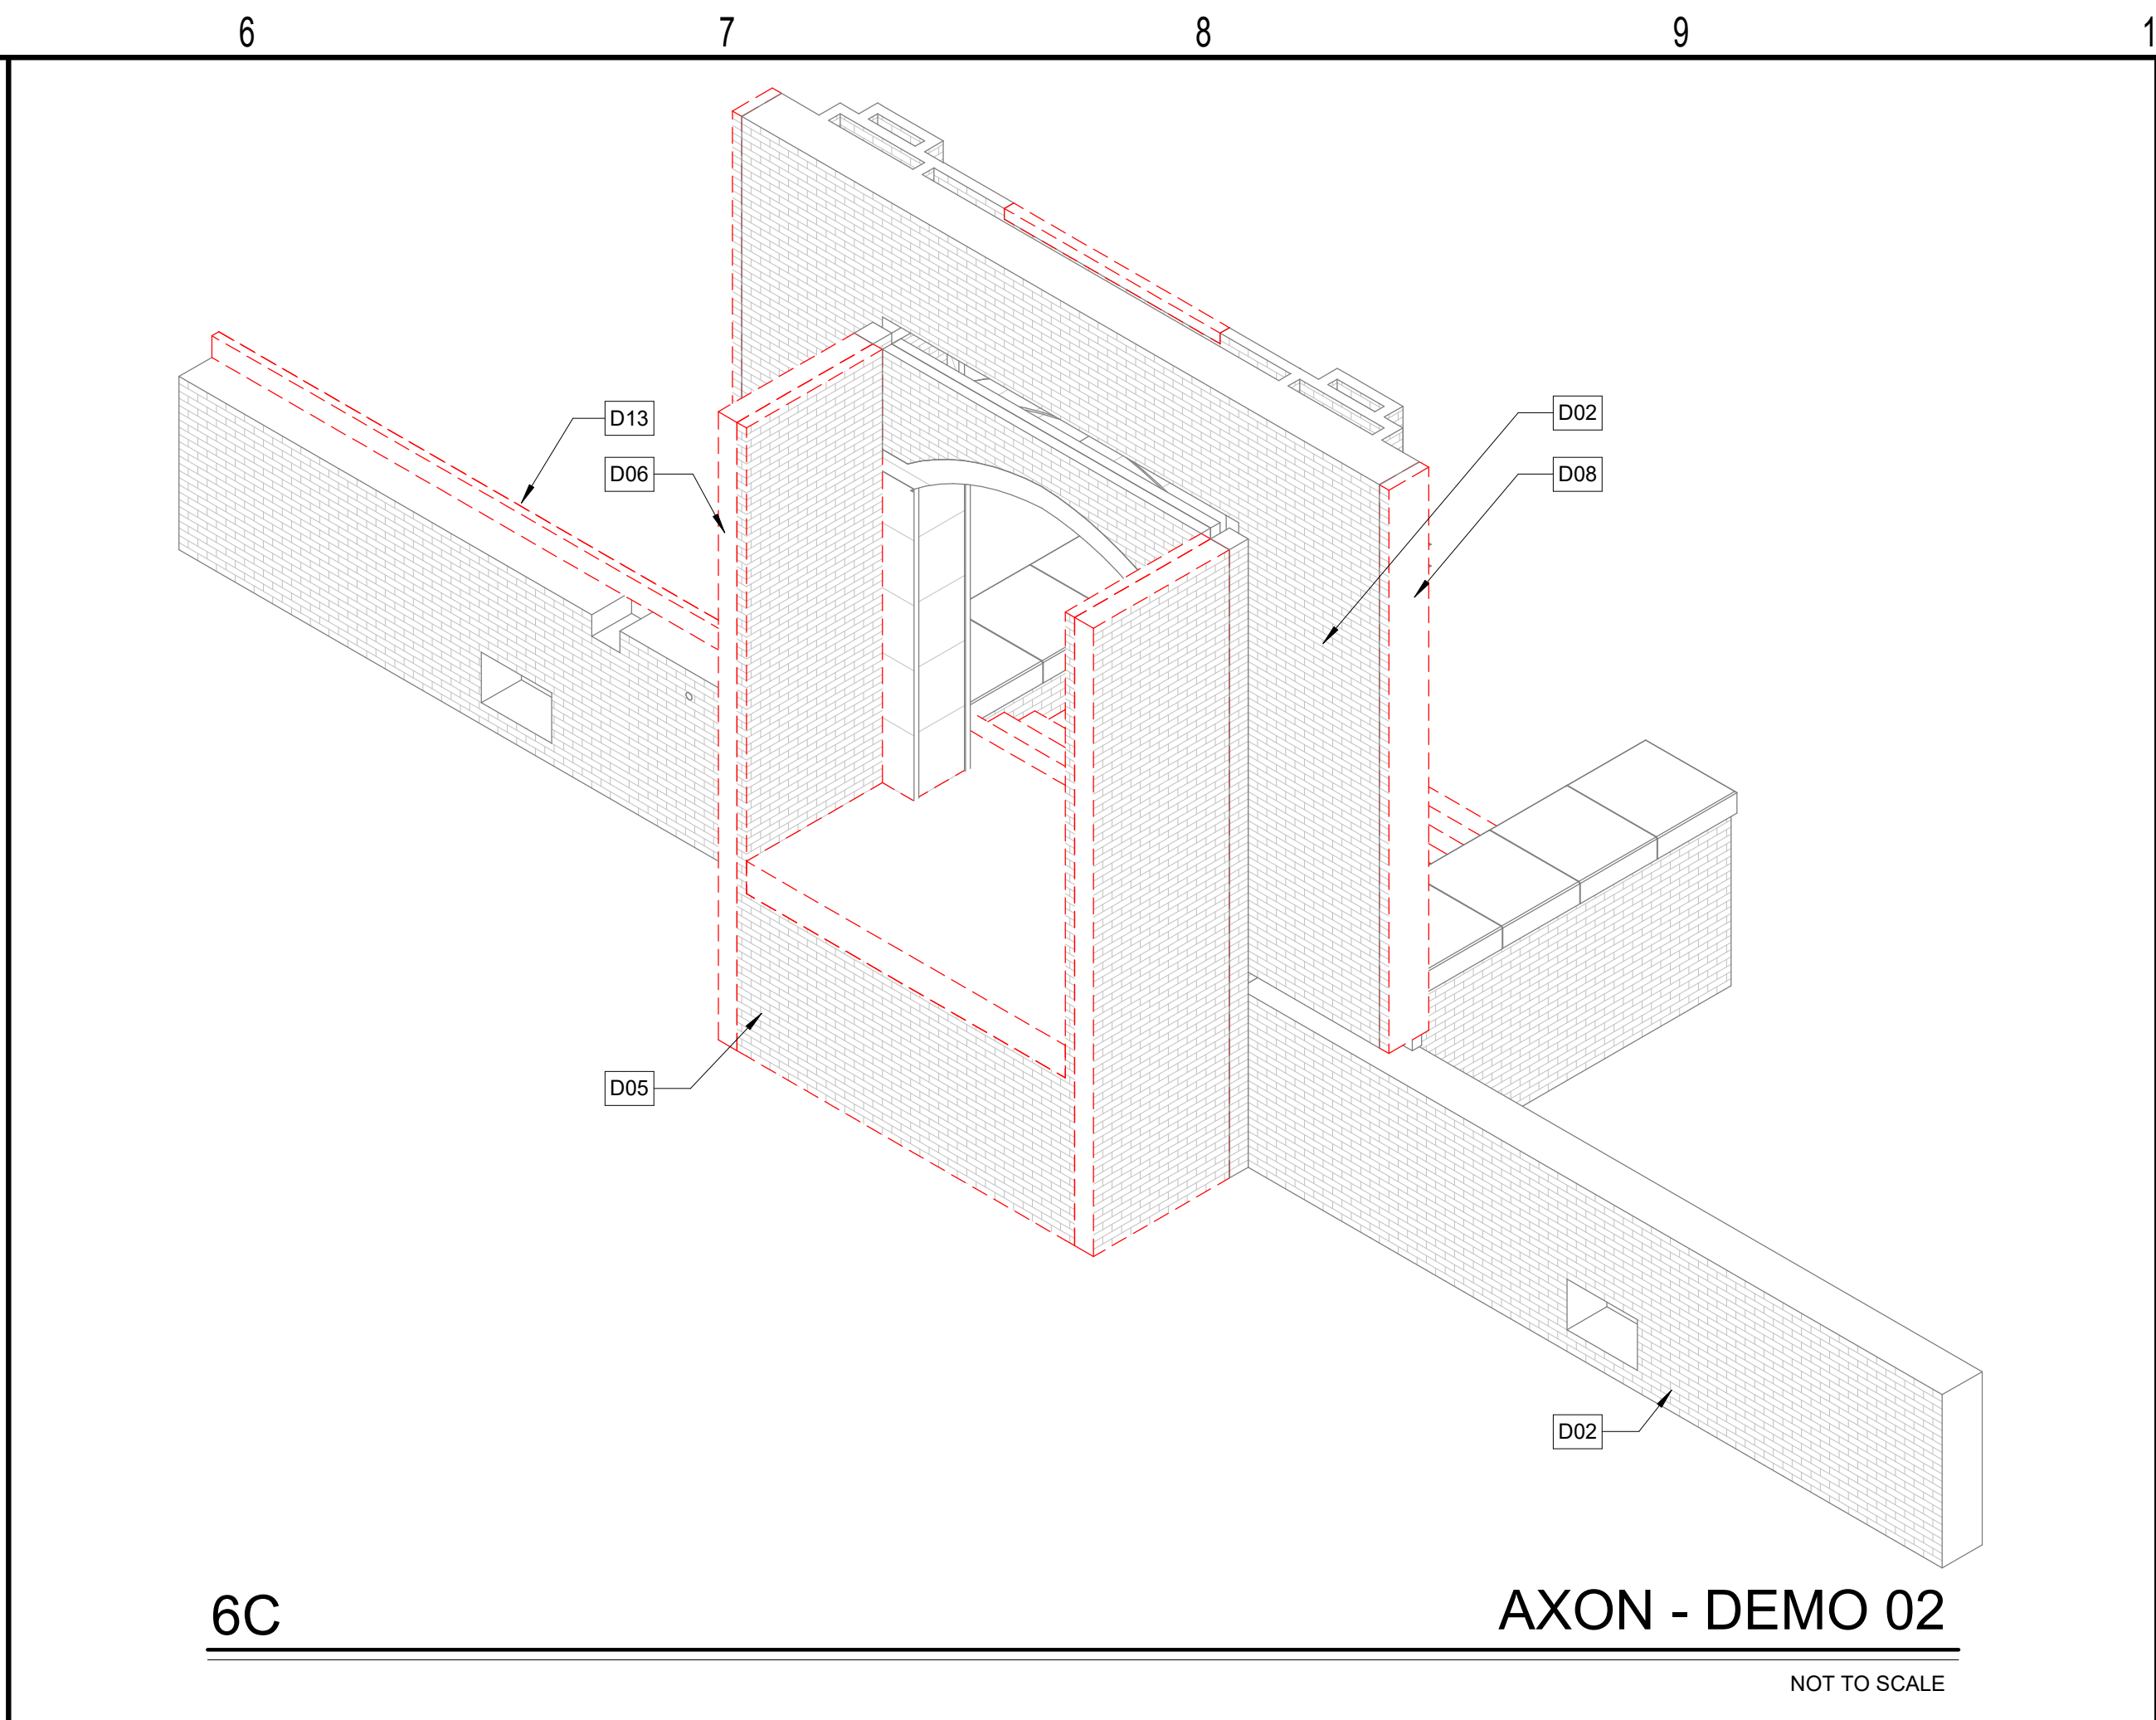
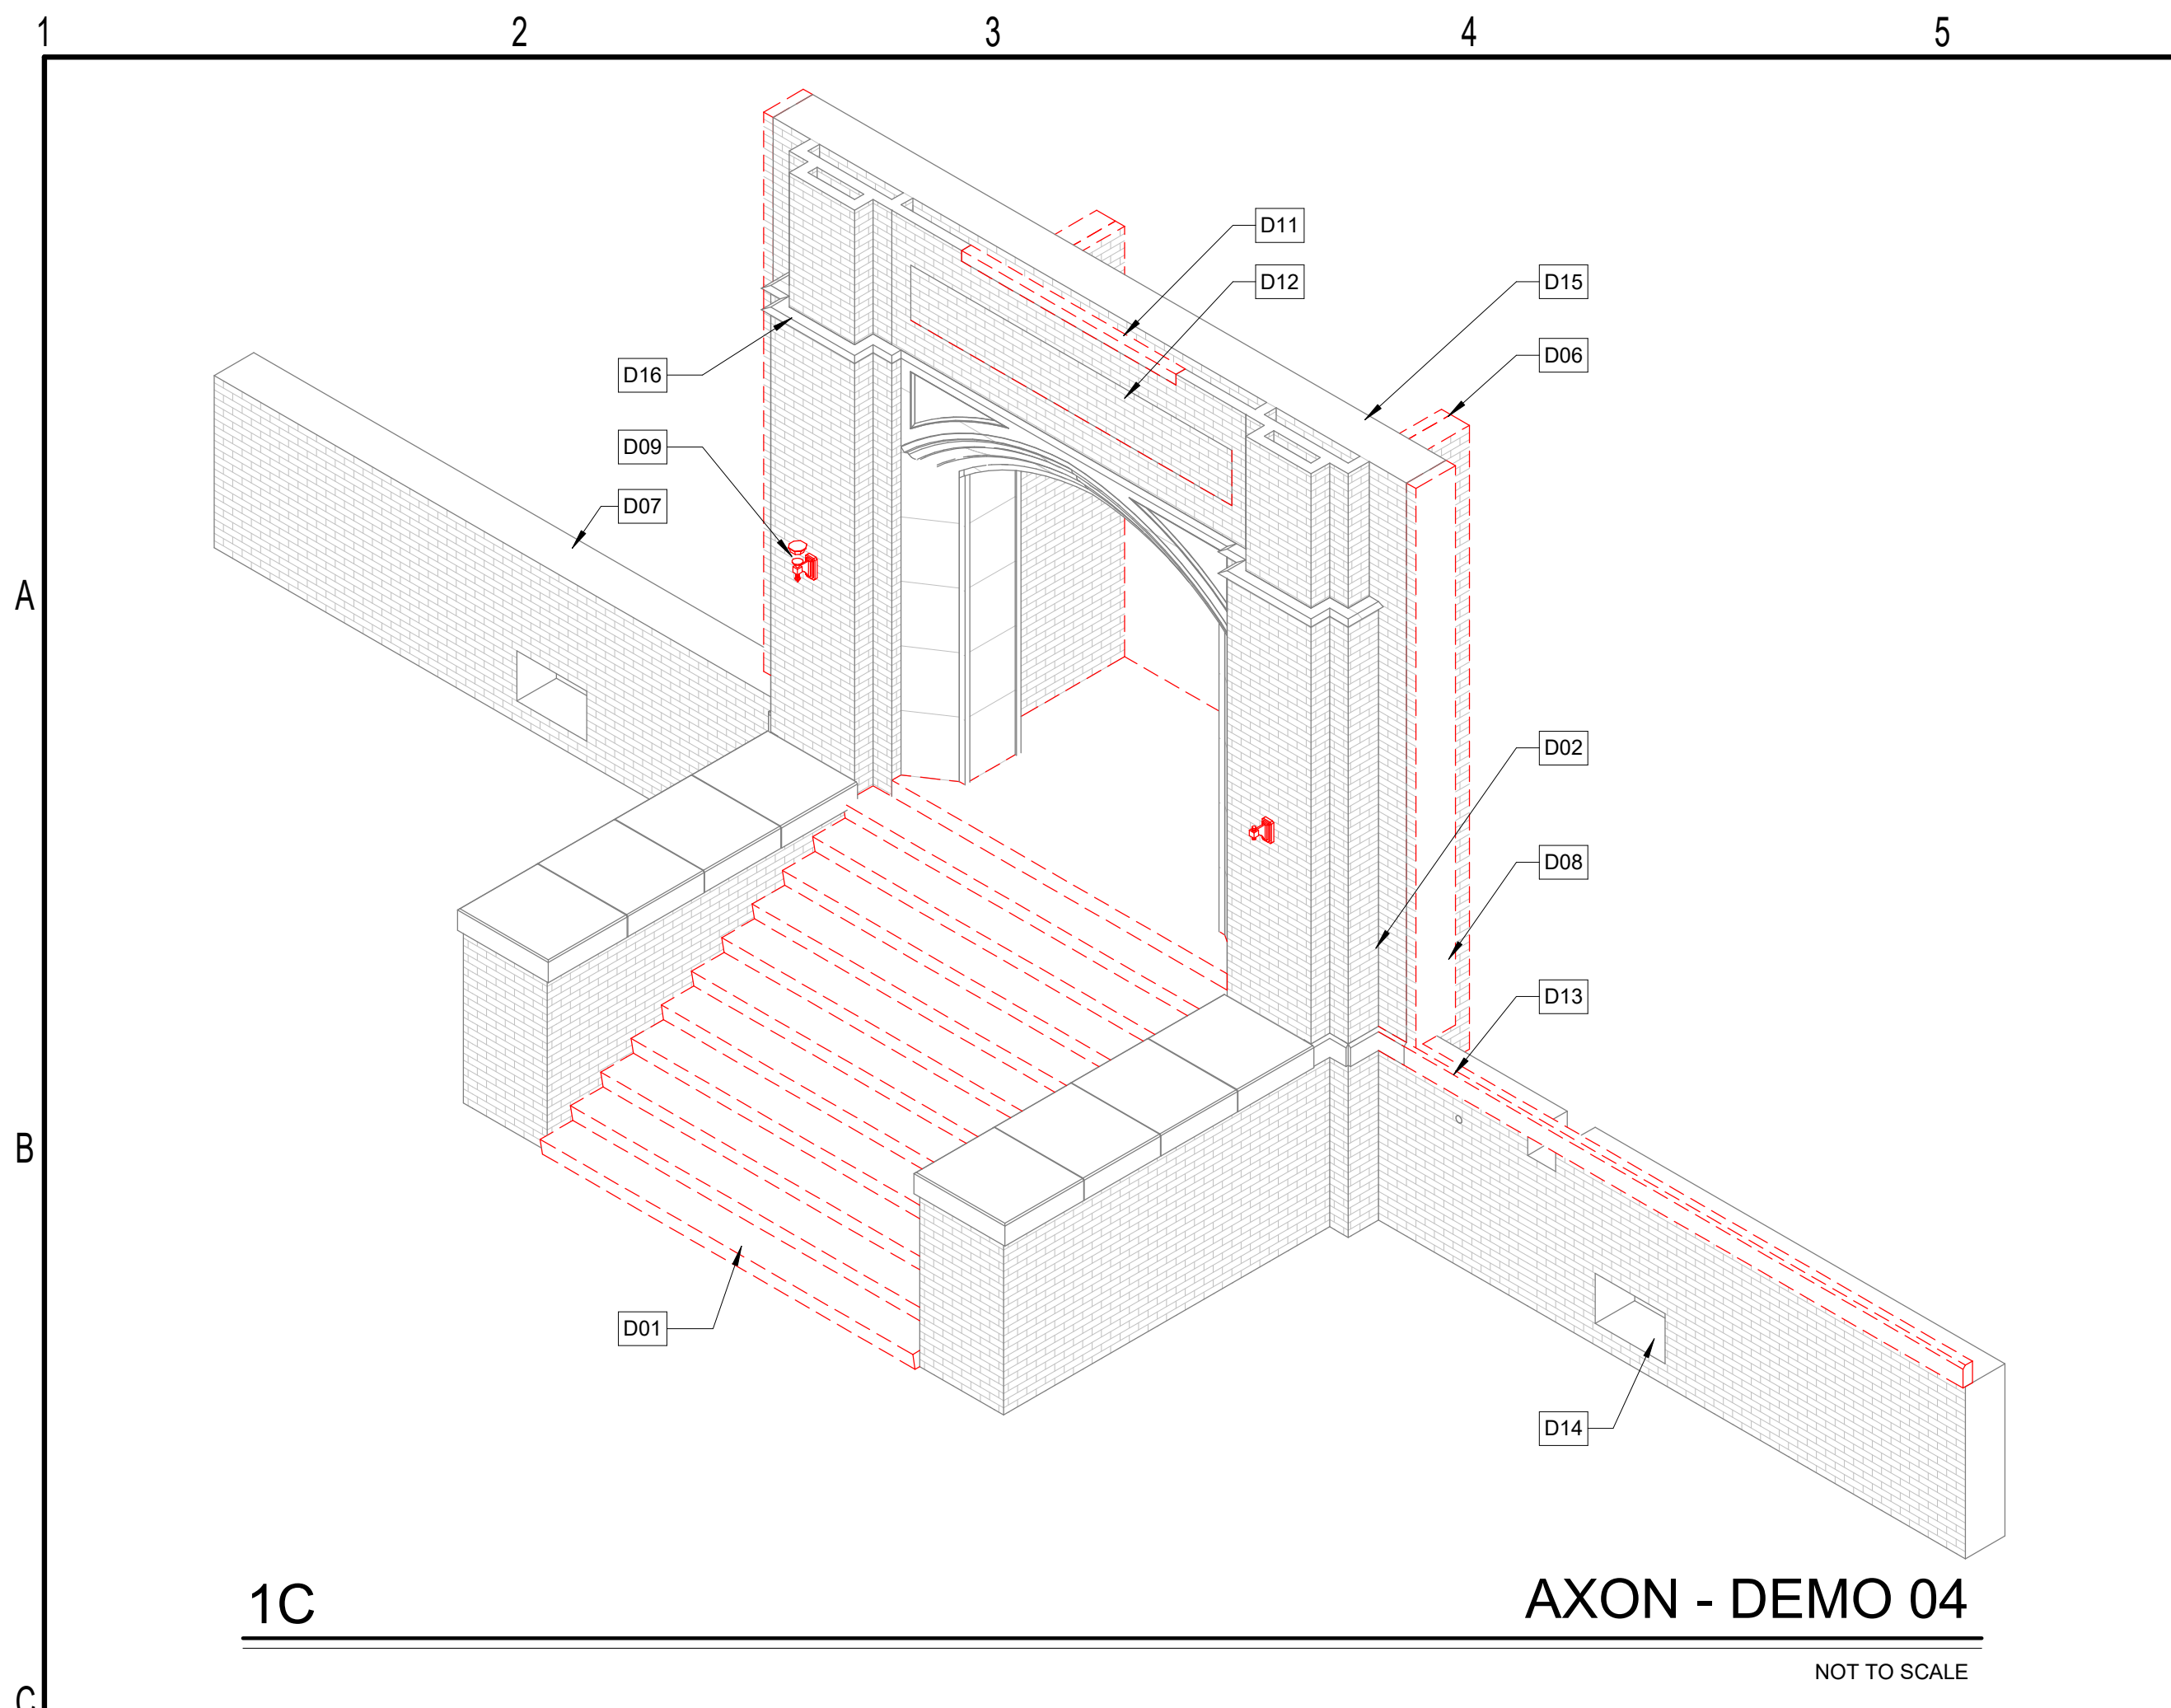
CONSTRUCTION DOCUMENTS

Revisions		
No.	Description	Date

date: 08/23/2024
commission: 23-670

sheet title: DEMO PLANS

sheet no.: **AD2.01**



- KEYED NOTES**
- D01 DEMO EXISTING CONCRETE STAIR AND MTL HANDRAIL. SHORE/BRACE ADJACENT MASONRY WALL AS REQUIRED TO PREVENT DAMAGE
 - D02 EXISTING MASONRY WALL TO REMAIN. PROTECT IN PLACE DURING DEMO. SEE REPAIR SHEETS FOR EXISTING BRICK TREATMENT
 - D03 REMOVE EXISTING LIMESTONE LEDGE CAP FOR REFINISHING. RESET IN ORIGINAL LOCATION ON EXISTING MASONRY WALLS. SEE REPAIR SHEETS FOR MORE DETAIL
 - D04 EXISTING LIMESTONE ARCH TO REMAIN. PROTECT IN PLACE. CLEAN, REPOINT, AND RESET STONE PANELS AS SPECIFIED BY REPAIR SHEETS
 - D05 DEMO EXISTING CONCRETE LANDING AND BEARING WALLS BELOW. PROTECT AND SHORE ADJACENT WALLS TO REMAIN
 - D06 DEMO EXISTING MASONRY WALL. SALVAGE EXISTING BRICK AS NEEDED AND STORE ON SITE. PROTECT ADJACENT WALLS DURING DEMO
 - D07 EXISTING MASONRY WING WALL TO REMAIN. CLEAN AND REPAIR TOP COURSE FOR NEW CONCRETE LEDGE CAP
 - D08 REMOVE PORTION OF EXISTING MASONRY AT END OF WALL IN PREPARATION FOR NEW END WALL MASONRY. WEAVE BRICK INTO THE EXISTING RATHER THAN A SAW CUT EDGE
 - D09 DEMO EXISTING (NON ENERGIZED) LIGHT FIXTURE AND ANY WIRING, ELECTRICAL BOXES, CONDUIT, ETC. PATCH AND REPAIR PER REPAIR AND PRESERVATION SHEETS
 - D10 EXISTING MASONRY BRICK WALL TO REMAIN. REMOVE EXISTING CHARRED FINISHES, MISC. ELECTRICAL REMNANTS. CLEAN AND PREP SURFACE FOR NEW MASONRY ANCHORS
 - D11 DEMO EXISTING CONCRETE WINDOW SILL AND INFILL WITH SALVAGED MASONRY. PREP TOP OF WALL FOR NEW CONCRETE PARAPET CAP
 - D12 REMOVE EXTERIOR LAYER OF BRICK AND TEMPORARILY SHORE OPENING FOR INSTALLATION OF SALVAGED CONCRETE SIGNAGE. VERIFY EXISTING SIGNAGE WIDTH AND HEIGHT PRIOR TO EXISTING BRICK REMOVAL
 - D13 DEMO EXISTING CONCRETE LEDGE CAP AND PREP TOP COURSE OF BRICK MASONRY FOR NEW CONCRETE CAP
 - D14 PREP EXISTING MASONRY OPENING FOR NEW SALVAGE BRICK INFILL
 - D15 REPAIR TOP OF EXISTING MASONRY WALL AS REQUIRED IN PREPARATION FOR NEW CONCRETE TOP CAP.
 - D16 EXISTING DECORATIVE LIMESTONE BANDING TO REMAIN. PROTECT AND REPAIR PER REPAIR/PRESERVATION SHEETS

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No.	Description	Date

date: 08/23/2024
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sheet title:
DEMO AXON DIAGRAMS

sheet no.:
AD9.01

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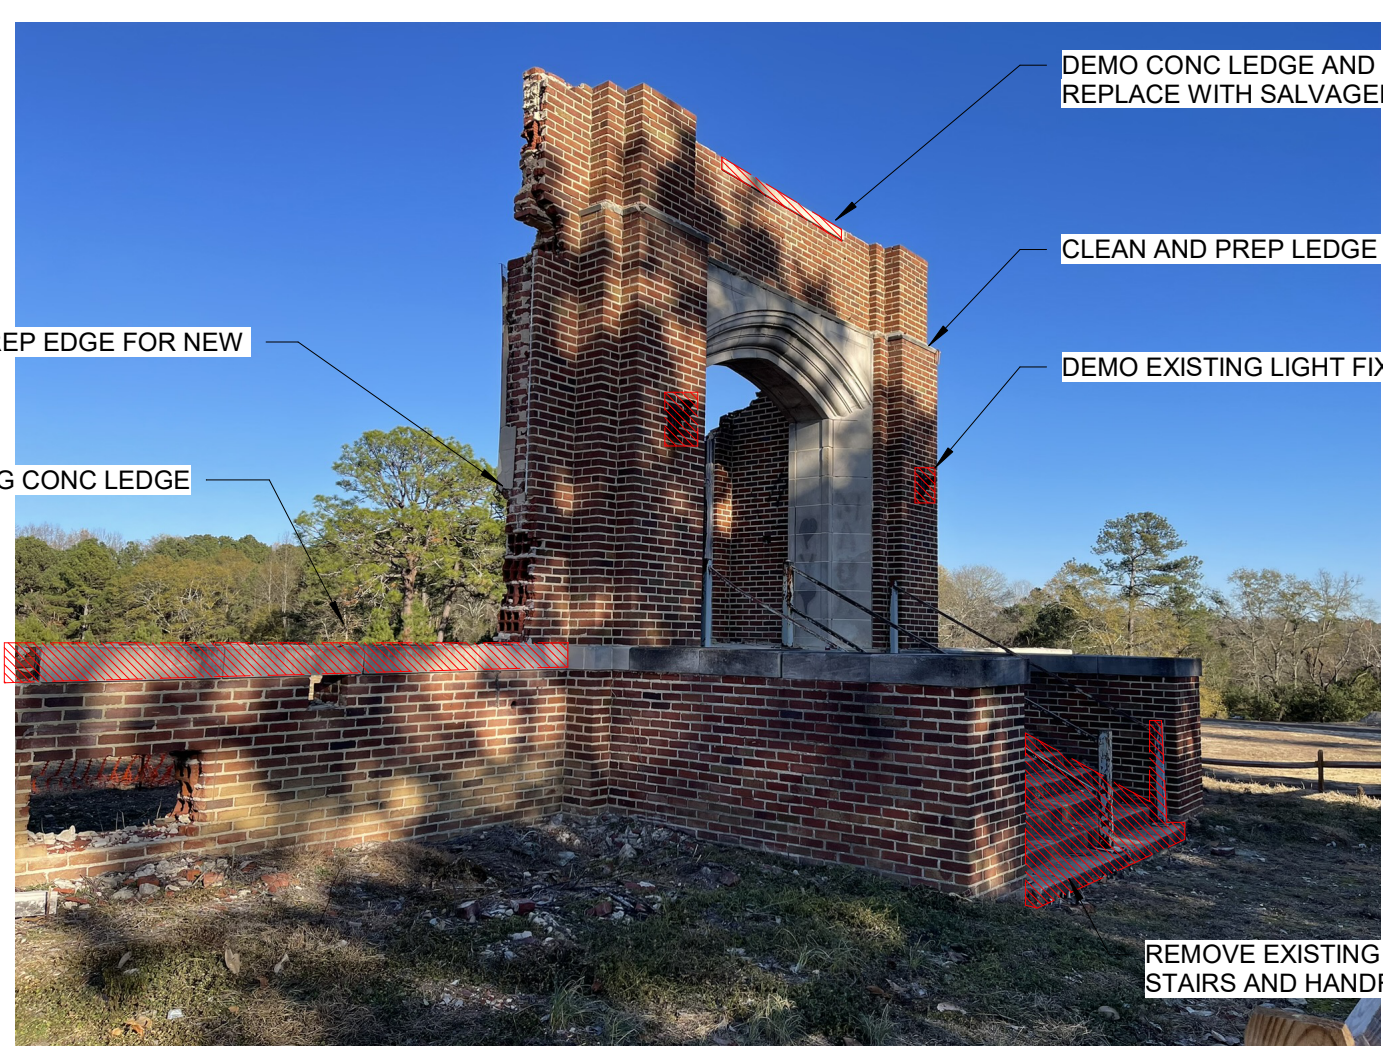
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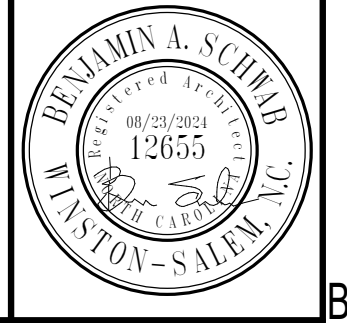
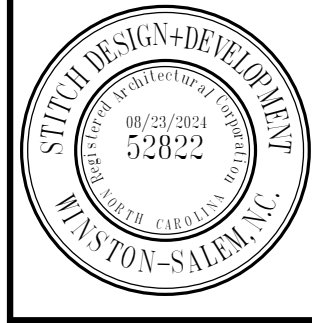
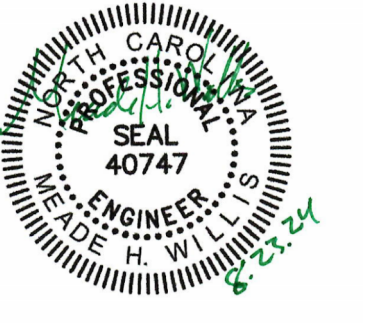
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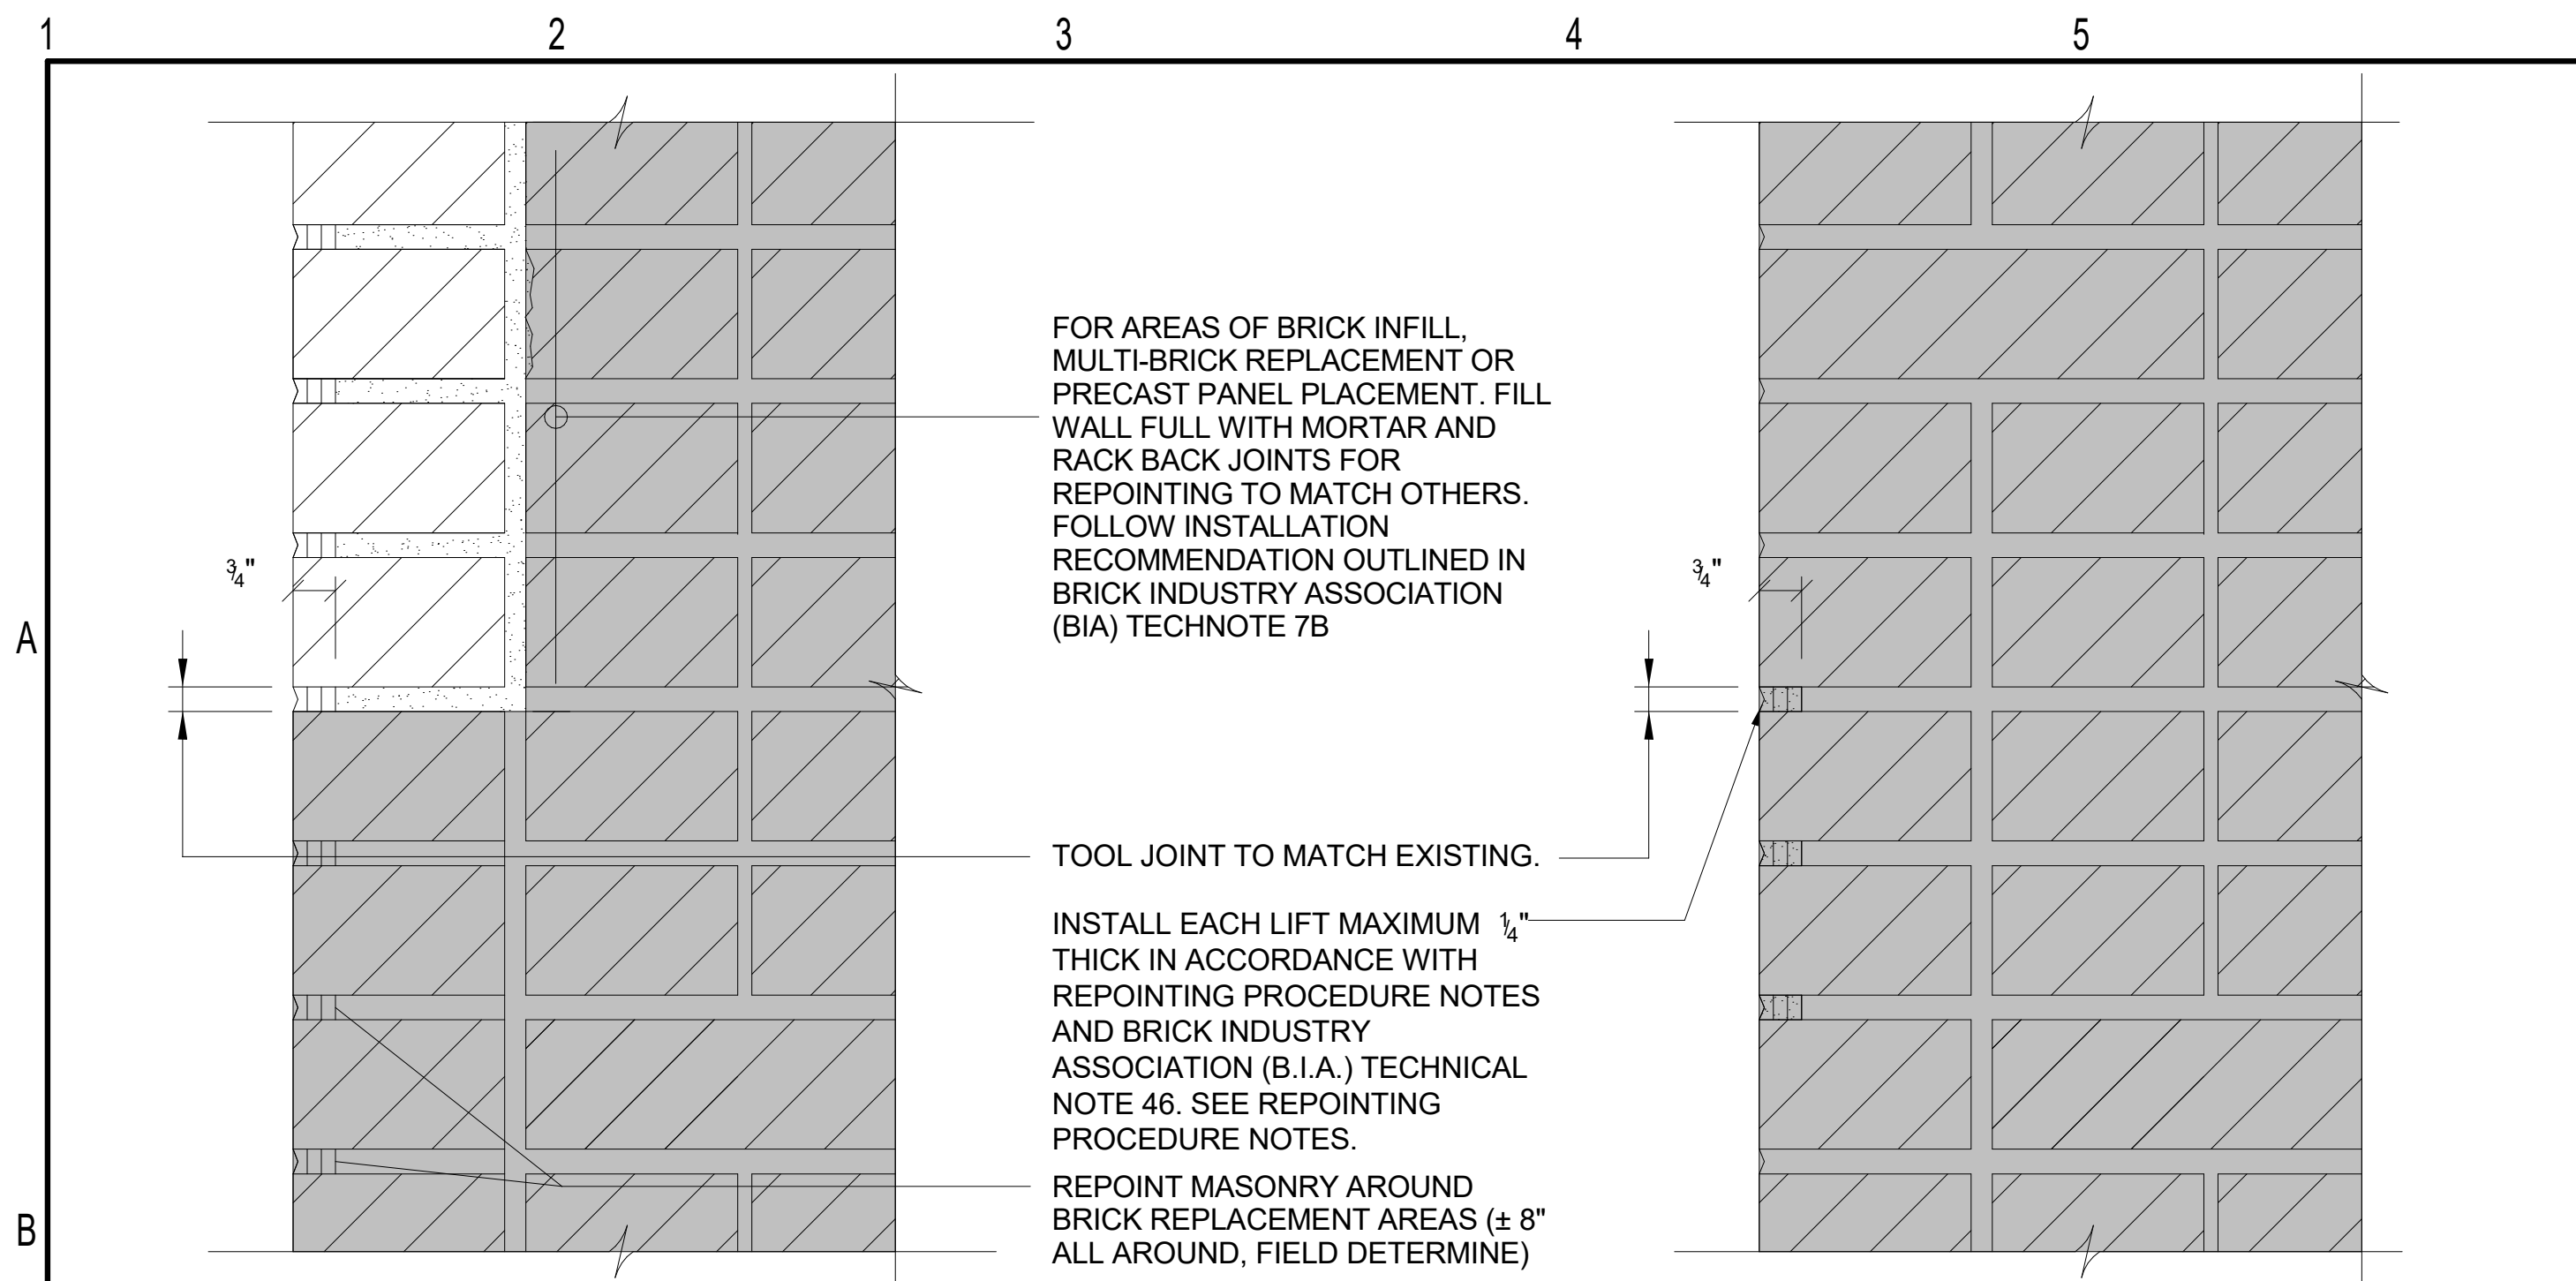
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EXISTING PHOTOS

sheet no.:

AD9.02



DEEP REPAIR
FULL MASONRY REPLACEMENT
APPLICABLE FOR LIMESTONE AND BRICK

SHALLOW REPAIR
REPOINTING OF EXISTING OR NEW
MORTAR JOINT
APPLICABLE FOR BRICK AND LIMESTONE

BRICK REPAIR/REPLACEMENT AND REPOINTING METHODS AND PROCEDURES:

REPLACE AND/OR REPOINT BRICK MASONRY WERE OUTLINED ON THE DRAWINGS. PROCEDURES AND METHODS SHALL BE IN ACCORDANCE WITH DRAWINGS, SPECIFICATIONS, AND THE BRICK INDUSTRY ASSOCIATION (BIA) TECHNICAL NOTES NO. 7B AND 46 AND AS OUTLINED BELOW. BIA TECHNOTES CAN BE DOWNLOADED (FREE OF CHARGE) AT WWW.GOBRIK.COM

BRICK REPLACEMENT

- REMOVE SELECT AREAS OF EXISTING DETERIORATED BRICK MASONRY AND OTHER BRICK VENEER WHERE OUTLINED IN THE DRAWINGS. SALVAGE EXISTING BRICK UNITS TO THE GREATEST EXTENT POSSIBLE. SALVAGED UNITS SHALL BE CLEANED FREE OF MORTAR, RESIDUE, AND CONTAMINANTS BY GRINDING AND CLEANING METHODS THAT DO NOT DAMAGE THE BRICK. WERE NEW BRICK UNITS MUST BE INCORPORATED AS REPLACEMENTS, SELECT AND INTERMINGLE NEW BRICK TO LESSEN AESTHETIC IMPACT ON SURROUNDING MASONRY. REPLACEMENT BRICK TO MATCH EXISTING AS CLOSELY AS POSSIBLE.
- PRIOR TO REINSTALLING BRICK UNITS, PREPARE ALL SURROUNDING MASONRY (± 8" IN ALL DIRECTIONS) VIA GRINDING-BACK MORTAR JOINTS IN TO A MINIMUM DEPTH OF 3/4" IN PREPARATION FOR REPOINTING. FOLLOW PROCEDURES FOR SHALLOW REPOINTING.
- REINSTALL BRICK UNITS AT PREVIOUSLY REMOVED AREAS. PLACE UNITS IN MORTAR IN ACCORDANCE WITH BIA AND INDUSTRY REQUIREMENTS. REPLACEMENT BRICKS SHALL BE TOOTHED INTO EXISTING RUNNING BOND.
- AFTER UNITS ARE INSTALLED, RAKE BACK NEW MORTAR JOINTS 3/4" MINIMUM.
- REPOINT REPLACEMENT BRICK AND SURROUNDING BRICK TO HAVE A UNIFORM APPEARANCE. FOLLOW SHALLOW REPOINTING PROCEDURES.

REPOINTING OF MORTAR JOINTS (BRICK AND LIMESTONE)

- WHERE MORTAR IS NOT YET REMOVED FROM JOINT, REMOVE MORTAR WITH HAND TOOLS OR SMALL POWER TOOLS IN SUCH A MANNER AS TO NOT DAMAGE THE BRICK OR LIMESTONE TO REMAIN. ANY DAMAGED BRICK SHALL BE REMOVED AND REPLACED IN ACCORDANCE WITH BRICK REPAIR PROCEDURES. REMOVE MORTAR TO A MINIMUM DEPTH OF 3/4-INCHES.
- REMOVE ALL DUST AND DEBRIS FROM THE JOINT BY WIRE BRUSHING AND BLOWING CLEAN WITH COMPRESSED AIR.
- REPOINTING MORTAR SHALL BE TYPE 'N' UNLESS OTHERWISE NOTED IN PROJECT SPECIFICATIONS. THE COLOR OF THE SAND AND COLORING AGENTS IF NECESSARY SHALL BE SELECTED TO MATCH EXISTING MORTAR. MORTAR SHALL BE PREHYDRATED TO REDUCE EXCESSIVE SHRINKAGE.
- JOINTS TO BE REPOINTED SHALL BE DAMPENED TO ENSURE A GOOD BOND. THE BRICK WORK MUST ABSORB ALL SURFACE WATER.
- JOINTS SHALL BE FILLED WITH PREHYDRATED MORTAR BY PACKING MORTAR TIGHTLY INTO THE JOINTS IN THIN LAYERS OF APPROXIMATELY 1/4" MAXIMUM. EACH LAYER SHALL BE "THUMBPRINT HARD" BEFORE APPLYING THE NEXT LAYER. THE JOINTS SHALL BE TOOLED TO MATCH THE EXISTING JOINTS AFTER THE LAST LAYER OF MORTAR IS "THUMBPRINT HARD".

1D TYP REPOINTING AND MASONRY REPLACEMENT DTL

NOT TO SCALE

CLEANING OF HISTORIC MATERIALS

THE INTENT OF CLEANING IS REMOVE DIRT, STAINS, AND OTHER UNSIGHTLY CONTAMINANTS FROM FINISH SURFACES TO CREATE A REJUVENATED SURFACE APPEARANCE. CLEANING IS NOT INTENDED TO RETURN HISTORIC SURFACES TO A LIKE NEW CONDITION. IT IS IMPERATIVE THAT CLEANING PROCEDURES AND OPERATIONS ARE CARRIED OUT IN A MANNER THAT DOES NOT CAUSE DAMAGE TO HISTORIC MATERIALS. HISTORIC MATERIALS SCHEDULED FOR CLEANING UNDER THIS SCOPE OF WORK INCLUDE BRICK, MORTAR, LIMESTONE, AND PRECAST CONCRETE. CRITERIA LISTED BELOW ARE CONSIDERED TO BE THE MINIMUM REQUIREMENTS.

CLEANING PROCEDURES SHALL COMPLY WITH DIRECTION GIVEN HERE AND WITH THE FOLLOWING INDUSTRY DOCUMENTS:

- BRICK INDUSTRY ASSOCIATION (BIA) TECHNICAL NOTE 20 - CLEANING BRICKWORK.
- INDIANA LIMESTONE HANDBOOK

GENERAL CLEANING

CLEANING SHALL CONSIST OF A "LIGHT WASH HAND CLEANING" USING A MILD DETERGENT OR OTHER CHEMICAL CLEANING AGENTS MANUFACTURED SPECIFICALLY FOR CLEANING OF THE INTENDED MATERIALS. CLEANING PROCEDURES SHALL BE A MULTI-STEP PROCESS THAT INCLUDES APPLICATION OF THE CLEANING AGENT COMBINED WITH HAND SCRUBBING OR SURFACE AGITATING AS DIRECT AND SURFACE RINSING WITH LOW PRESSURE POTABLE WATER BETWEEN APPLICATION OF EACH CLEANING AGENT. CHEMICAL CLEANING AGENTS SHALL BE SELECTED AS PART OF A TOTAL CLEANING SYSTEM AND SHALL BE FROM A SINGLE MANUFACTURER AS FOLLOWS:

- PREWASH AGENT
- CLEANING AGENT
- AFTERWASH/NEUTRALIZING AGENT

ALL CLEANING AGENTS SELECTED FOR USE BY THE CONTRACTOR SHALL BE EQUAL TO: PROSOCO SURE KLEAN AND PROSOCO ENVIROKLEAN PRODUCTS LINES FOR THE APPLICABLE MATERIALS.

THE CONTRACTOR SHALL FOLLOW THE MANUFACTURER'S APPLICATION INSTRUCTIONS INCLUDING SURFACE PREPARATION AND CHEMICAL DWELL TIME. REPEAT APPLICATIONS OF ONE OR MORE OF THE CLEANING STEPS MAY BE REQUIRED TO SUFFICIENTLY CLEAN THE SURFACE WITHOUT DAMAGING THE EXISTING MATERIALS.

FOR LOCALIZED DEEP OR EMBEDDED STAINS A PASTE POLUTICE SHALL BE USED TO DRAW-OUT THE STAIN.

ALTERNATIVES CLEANING METHODS:

STEAM CLEANING MAY BE USED IF SHOWN TO BE SUCCESSFUL AND NON-DAMAGING THROUGH A MOCK-UP.

MOCK-UP

PERFORM A MOCK-UP OF CLEANING PROCESS ON AN AREA OF BRICK, LIMESTONE, AND CONCRETE. THE MOCK-UPS SHALL NOT BE SMALLER THAN 10 S.F. ON EACH SURFACE MATERIAL BEING CLEANED.

1F CLEANING OF HISTORIC MATERIALS

NOT TO SCALE

100% SOLIDS WATER REPELLANT INSTALLATION METHODS AND PROCEDURES:

THE INTENT OF THIS REPAIR IS TO PRESERVE AND PROTECT THE BRICK MASONRY AND CAST STONE SURFACES BY INSTALLING A PENETRATING, BREATHABLE, WATER REPELLANT. WATER REPELLANT SHALL BE EQUAL TO PROTECTOSILO CHEM-TRETE PB 1000 AS MANUFACTURED BY EVONIK INDUSTRIES. INSTALL MATERIAL IN ACCORDANCE WITH THE MANUFACTURER'S INSTRUCTIONS AND METHODS AND PROCEDURES OUTLINED HEREIN.


- PERFORM A MOCK-UP TO ENSURE THAT EXISTING MASONRY WILL ACCEPT WATER REPELLANT TO REFUSAL. PERFORM A SMALL MOCK-UP ON LIMESTONE ENSURE COMPATIBILITY AND NOT COLOR CHANGE.
- ALLOW ALL NEW MASONRY, REPOINTING MORTAR, AND CONCRETE TO CURE FOR A MINIMUM TIME RECOMMENDED BY THE MANUFACTURER. ALL PATCHING MATERIALS, SEALANT, CAULKING, ETC... MUST CURE PRIOR TO INSTALLATION OF WATER REPELLANT.
- THOROUGHLY CLEAN ALL SURFACES TO RECEIVE WATER REPELLANT VIA WATERBLASTING. CLEANING SHALL REMOVE ALL CORROSION STAINING, DIRT, DUST, EFFLORESCENCE, MOLD, SALT, GREASE, OIL, ASPHALT, CURING COMPOUNDS, PAINT, COATINGS, AND OTHER FOREIGN MATERIALS.
- APPLY PRODUCT IN FLOOD COATS AT THE RATES LISTED BY THE MANUFACTURER AND VIA ANY OF THE FOLLOWING METHODS: LOW PRESSURE PUMPING DEVICE WITH A WET FAN TYPE SPRAY NOZZLE, POWER ROLLER WITH A 1" NAP OR BY BRUSH. SEE MANUFACTURER'S PRINTED INSTRUCTIONS FOR ADDITIONAL REQUIREMENTS WHEN APPLYING TO VERTICAL SURFACES.
- TAKE MEASURES TO PROTECT ALL SURROUNDING MATERIALS, INCLUDING BUT NOT LIMITED TO, GLASS, METAL, PLASTIC, WATERPROOFING MEMBRANE, AND OTHER NON POROUS SUBSTRATES FROM DIRECT CONTACT OR OVERSPRAY.
- DO NOT DILUTE THE WATER REPELLANT IN THE FIELD.
- DO NOT APPLY WATER REPELLANT IF SURFACE TEMPERATURES ARE OUTSIDE THE MANUFACTURER'S RECOMMENDED RANGE, IF RAIN IS EXPECTED WITHIN FOUR HOURS FOLLOWING THE APPLICATION, OR IF HIGH WINDS OR OTHER CONDITIONS PREVENT PROPER APPLICATION. SUBSTRATE SHOULD BE ALLOWED TO DRY FOR AT LEAST 48 HOURS AFTER RAIN HAS PROCEEDED APPLICATION.

PRE-INSTALLATION MOCK-UP

RILEM TUBE TEST INSTALLATION METHODS AND TEST PROCEDURES:

THE INTENT OF THIS MOCK-UP TEST IS TO VERIFY THE PERFORMANCE OF THE SPECIFIED WATER REPELLANT AS-INSTALLED ON EXISTING MASONRY AND CAST STONE SUBSTRATES.

- INSTALL THE REPELLANT MOCK-UP PANEL PRIOR TO, OR AT THE START OF THE REPAIR WORK.
- COORDINATE LOCATION OF MOCK-UP PANEL WITH THE ARCHITECT.
- INSTALL THE WATER REPELLANT PRODUCTS AS PER THE MANUFACTURER'S INSTRUCTIONS. THOROUGHLY CLEAN AND ALLOW THE TEST AREA TO DRY FOR 24-48 HOURS PRIOR TO INSTALLATION OF REPELLANT MOCK-UP.
- AFTER INSTALLATION OF THE REPELLANT MOCK-UP A CURING PERIOD OF AT LEAST 7-DAYS WILL BE REQUIRED BEFORE TESTING CAN OCCUR.
- THE TEST WILL BE PERFORMED BY THE ARCHITECT WITH THE CONTRACTORS ASSISTANCE. PLACE RILEM TUBES ON THE WALL NO SOONER THAN 30-MINUTES PRIOR TO COMMENCEMENT OF TESTING.
- TESTING WILL CONSIST OF FILLING THE RILEM TUBE AND MONITORING WATER ABSORPTION BY THE SUBSTRATE AT THE FOLLOWING TIMED INTERVALS:
1 MINUTE, 5 MINUTES, 10 MINUTES
- PERIODIC REFILLING OF RILEM TUBES MAY BE REQUIRED DEPENDING ON THE EFFECTIVENESS OF THE REPELLANT PRODUCT AND THE POROSITY OF THE MASONRY SUBSTRATES.

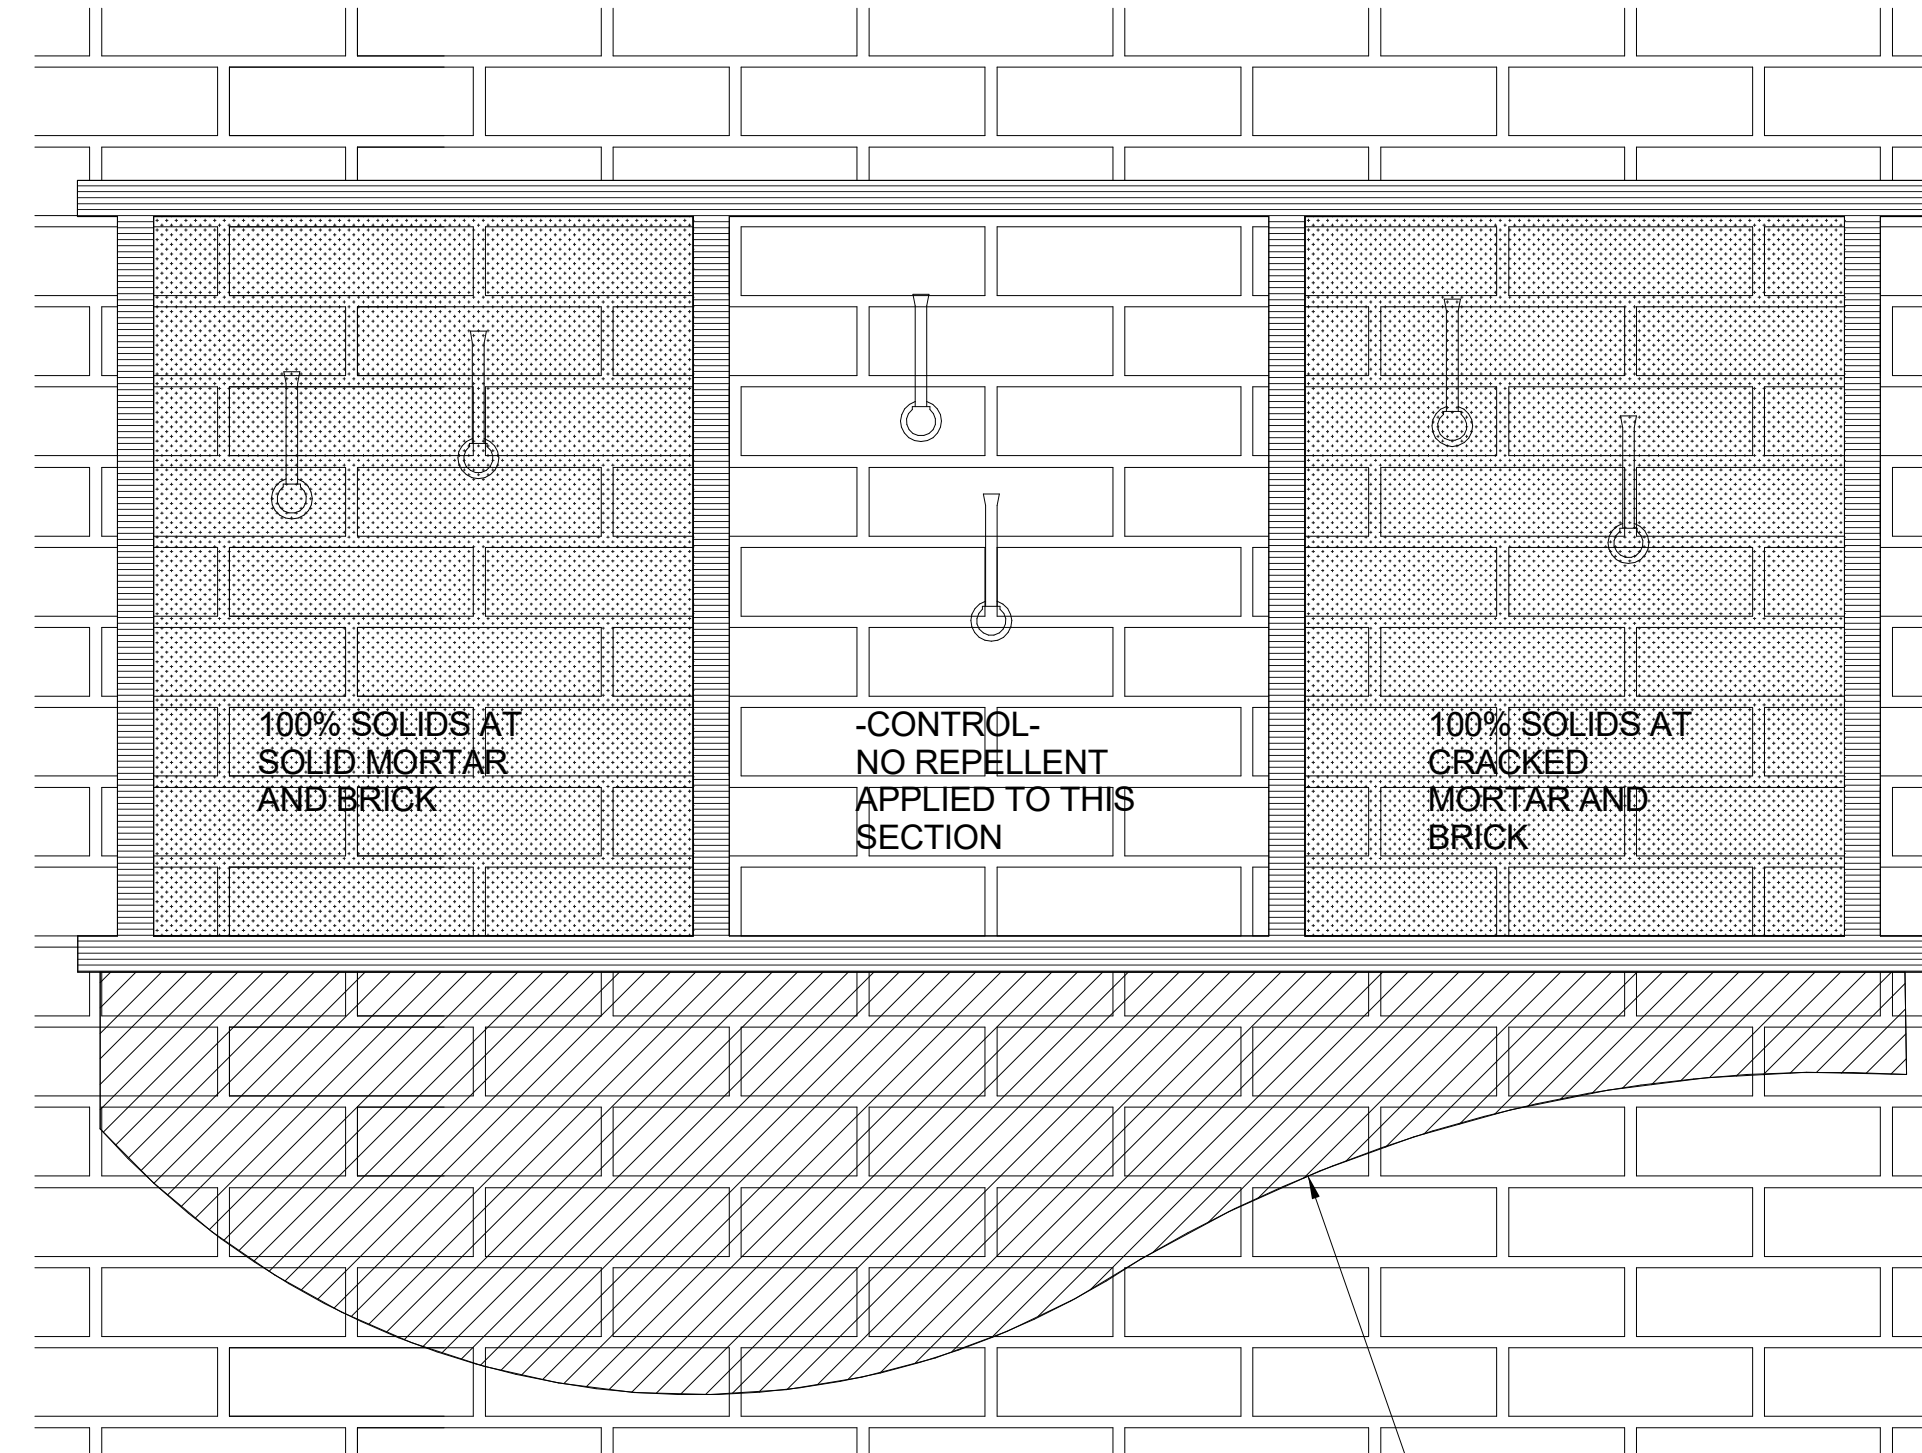

TWO (2) RILEM TUBE TESTS TO BE PERFORMED AT EACH MOCK-UP PANEL (6 TUBES TOTAL).

SET EACH TUBE IN PUTTY AND PRESS FIRMLY TO SEAL TUBE AGAINST MASONRY AT THE FOLLOWING LOCATIONS (PER PANEL):

1 TUBE AT 'T' JOINT

1 TUBE ON BRICK FACE




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PENETRATING BREATHABLE WATER REPELLANT

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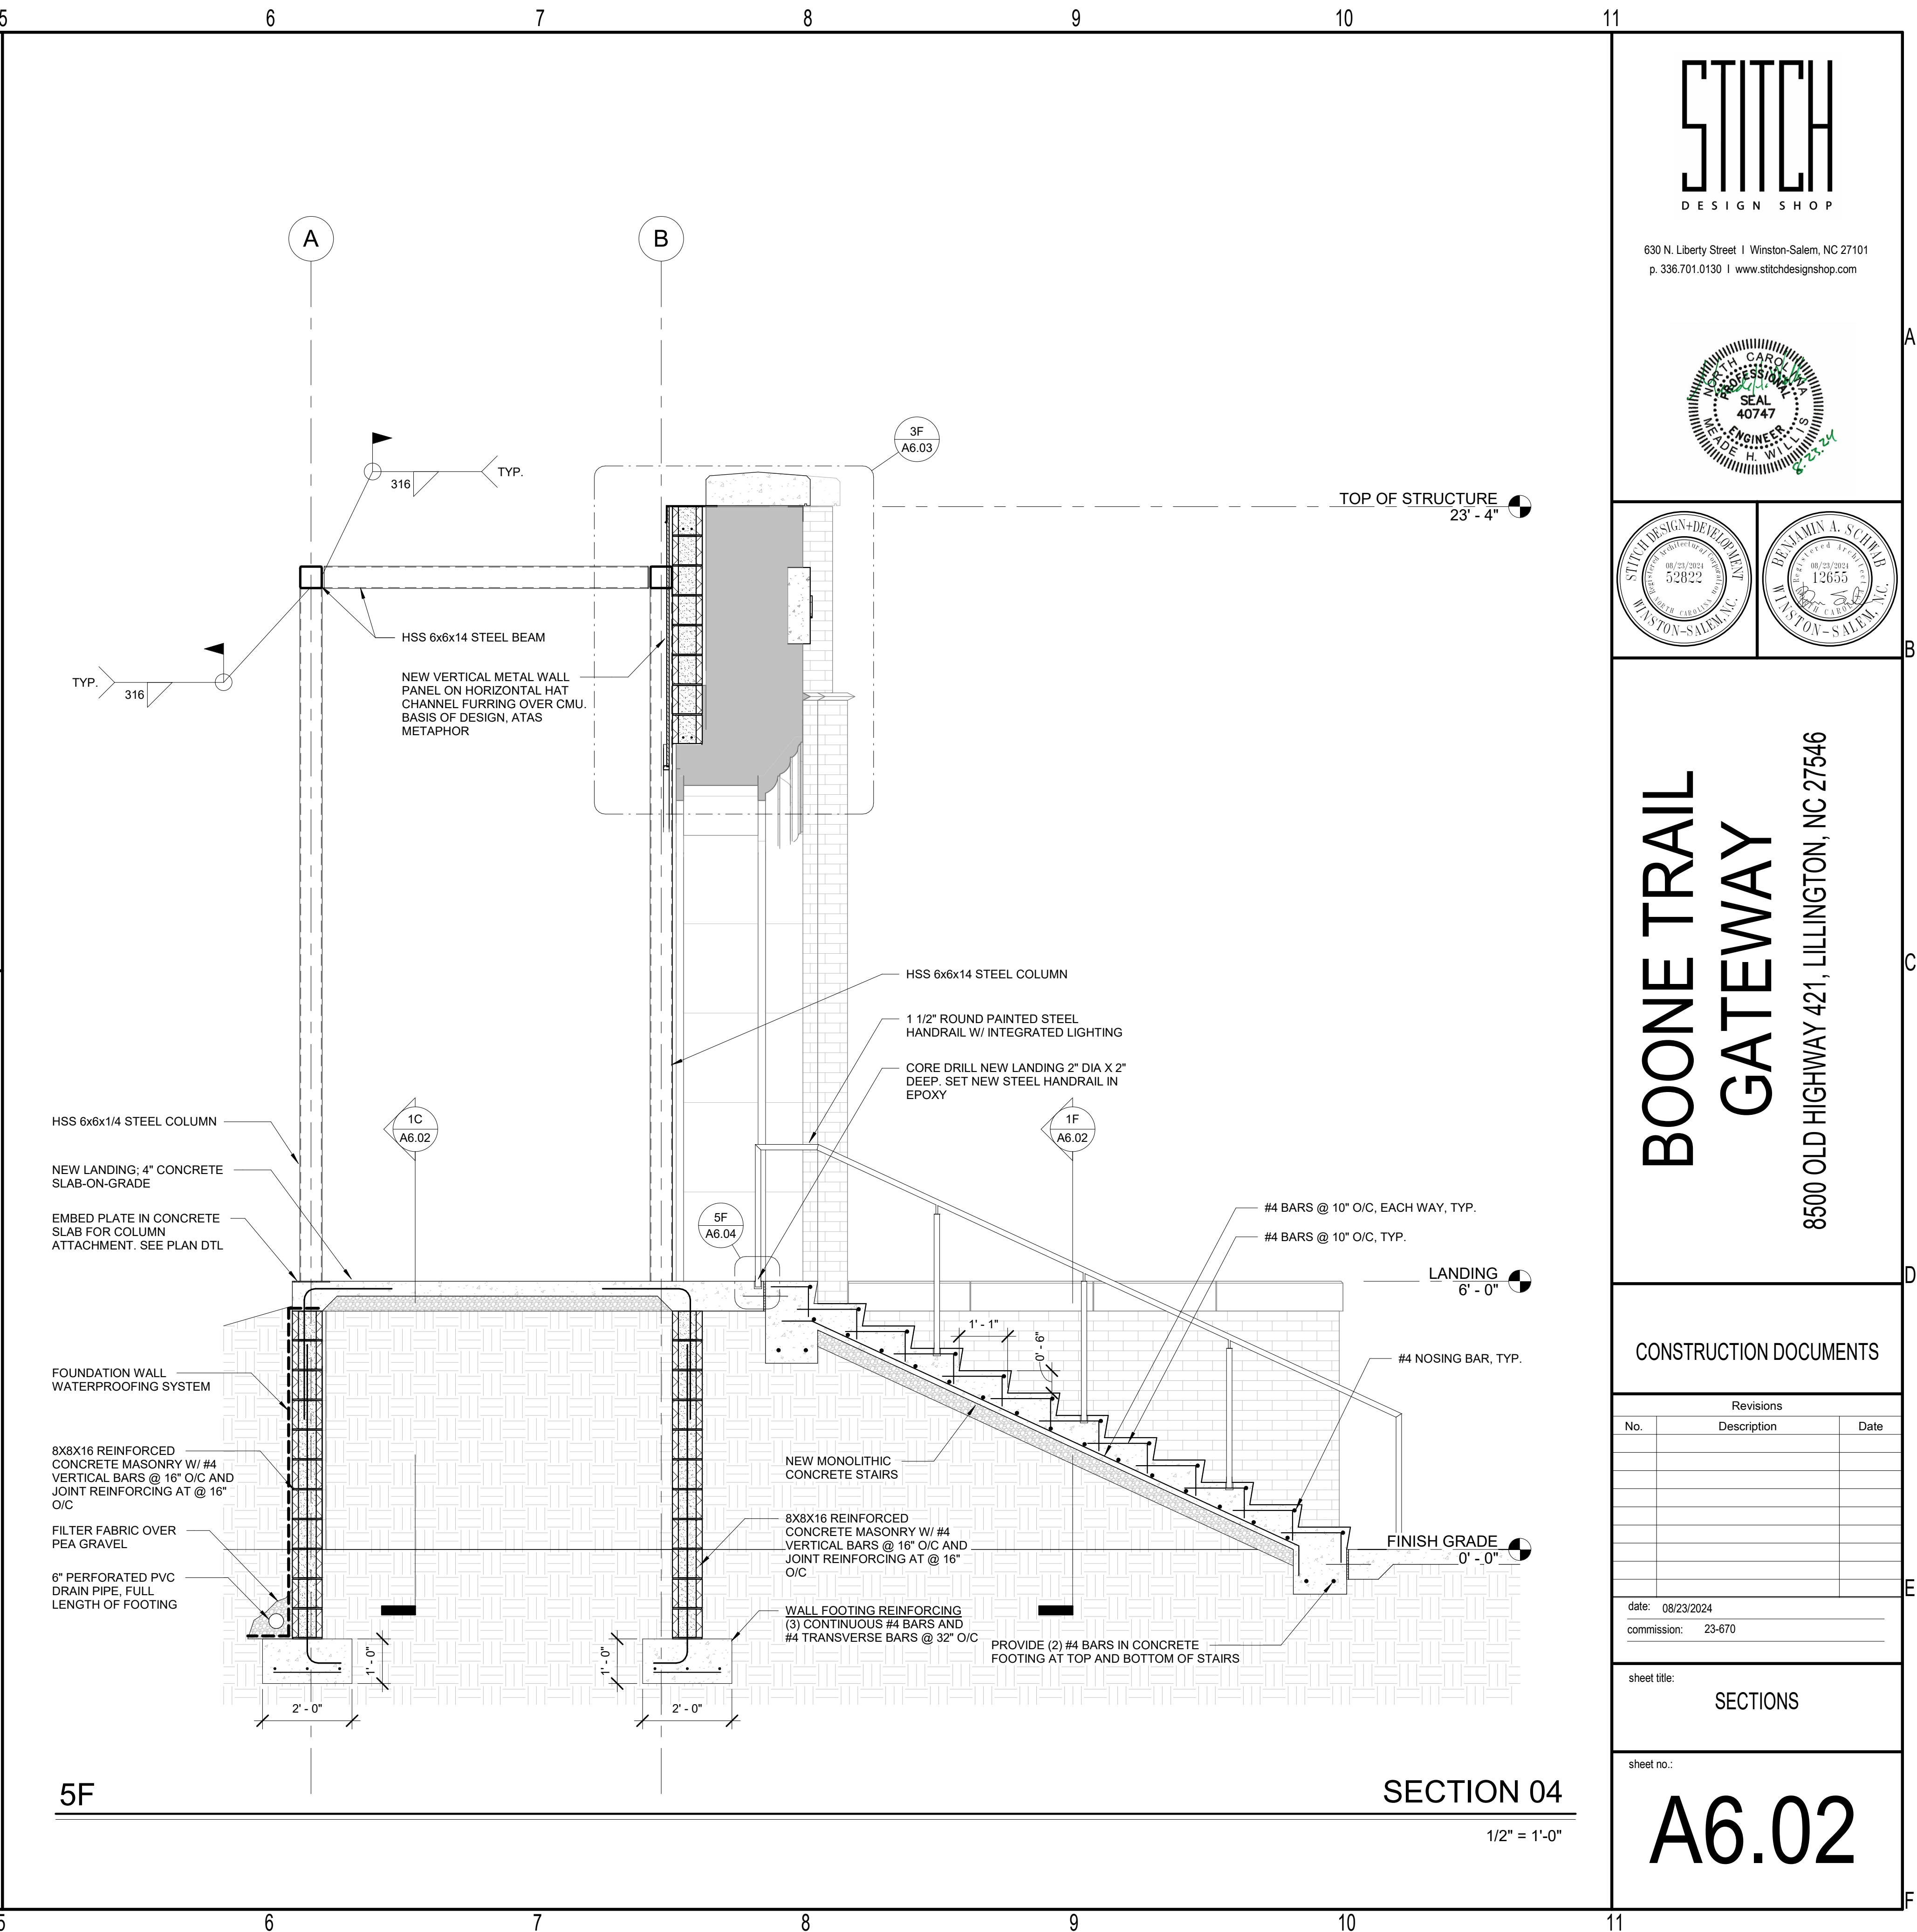
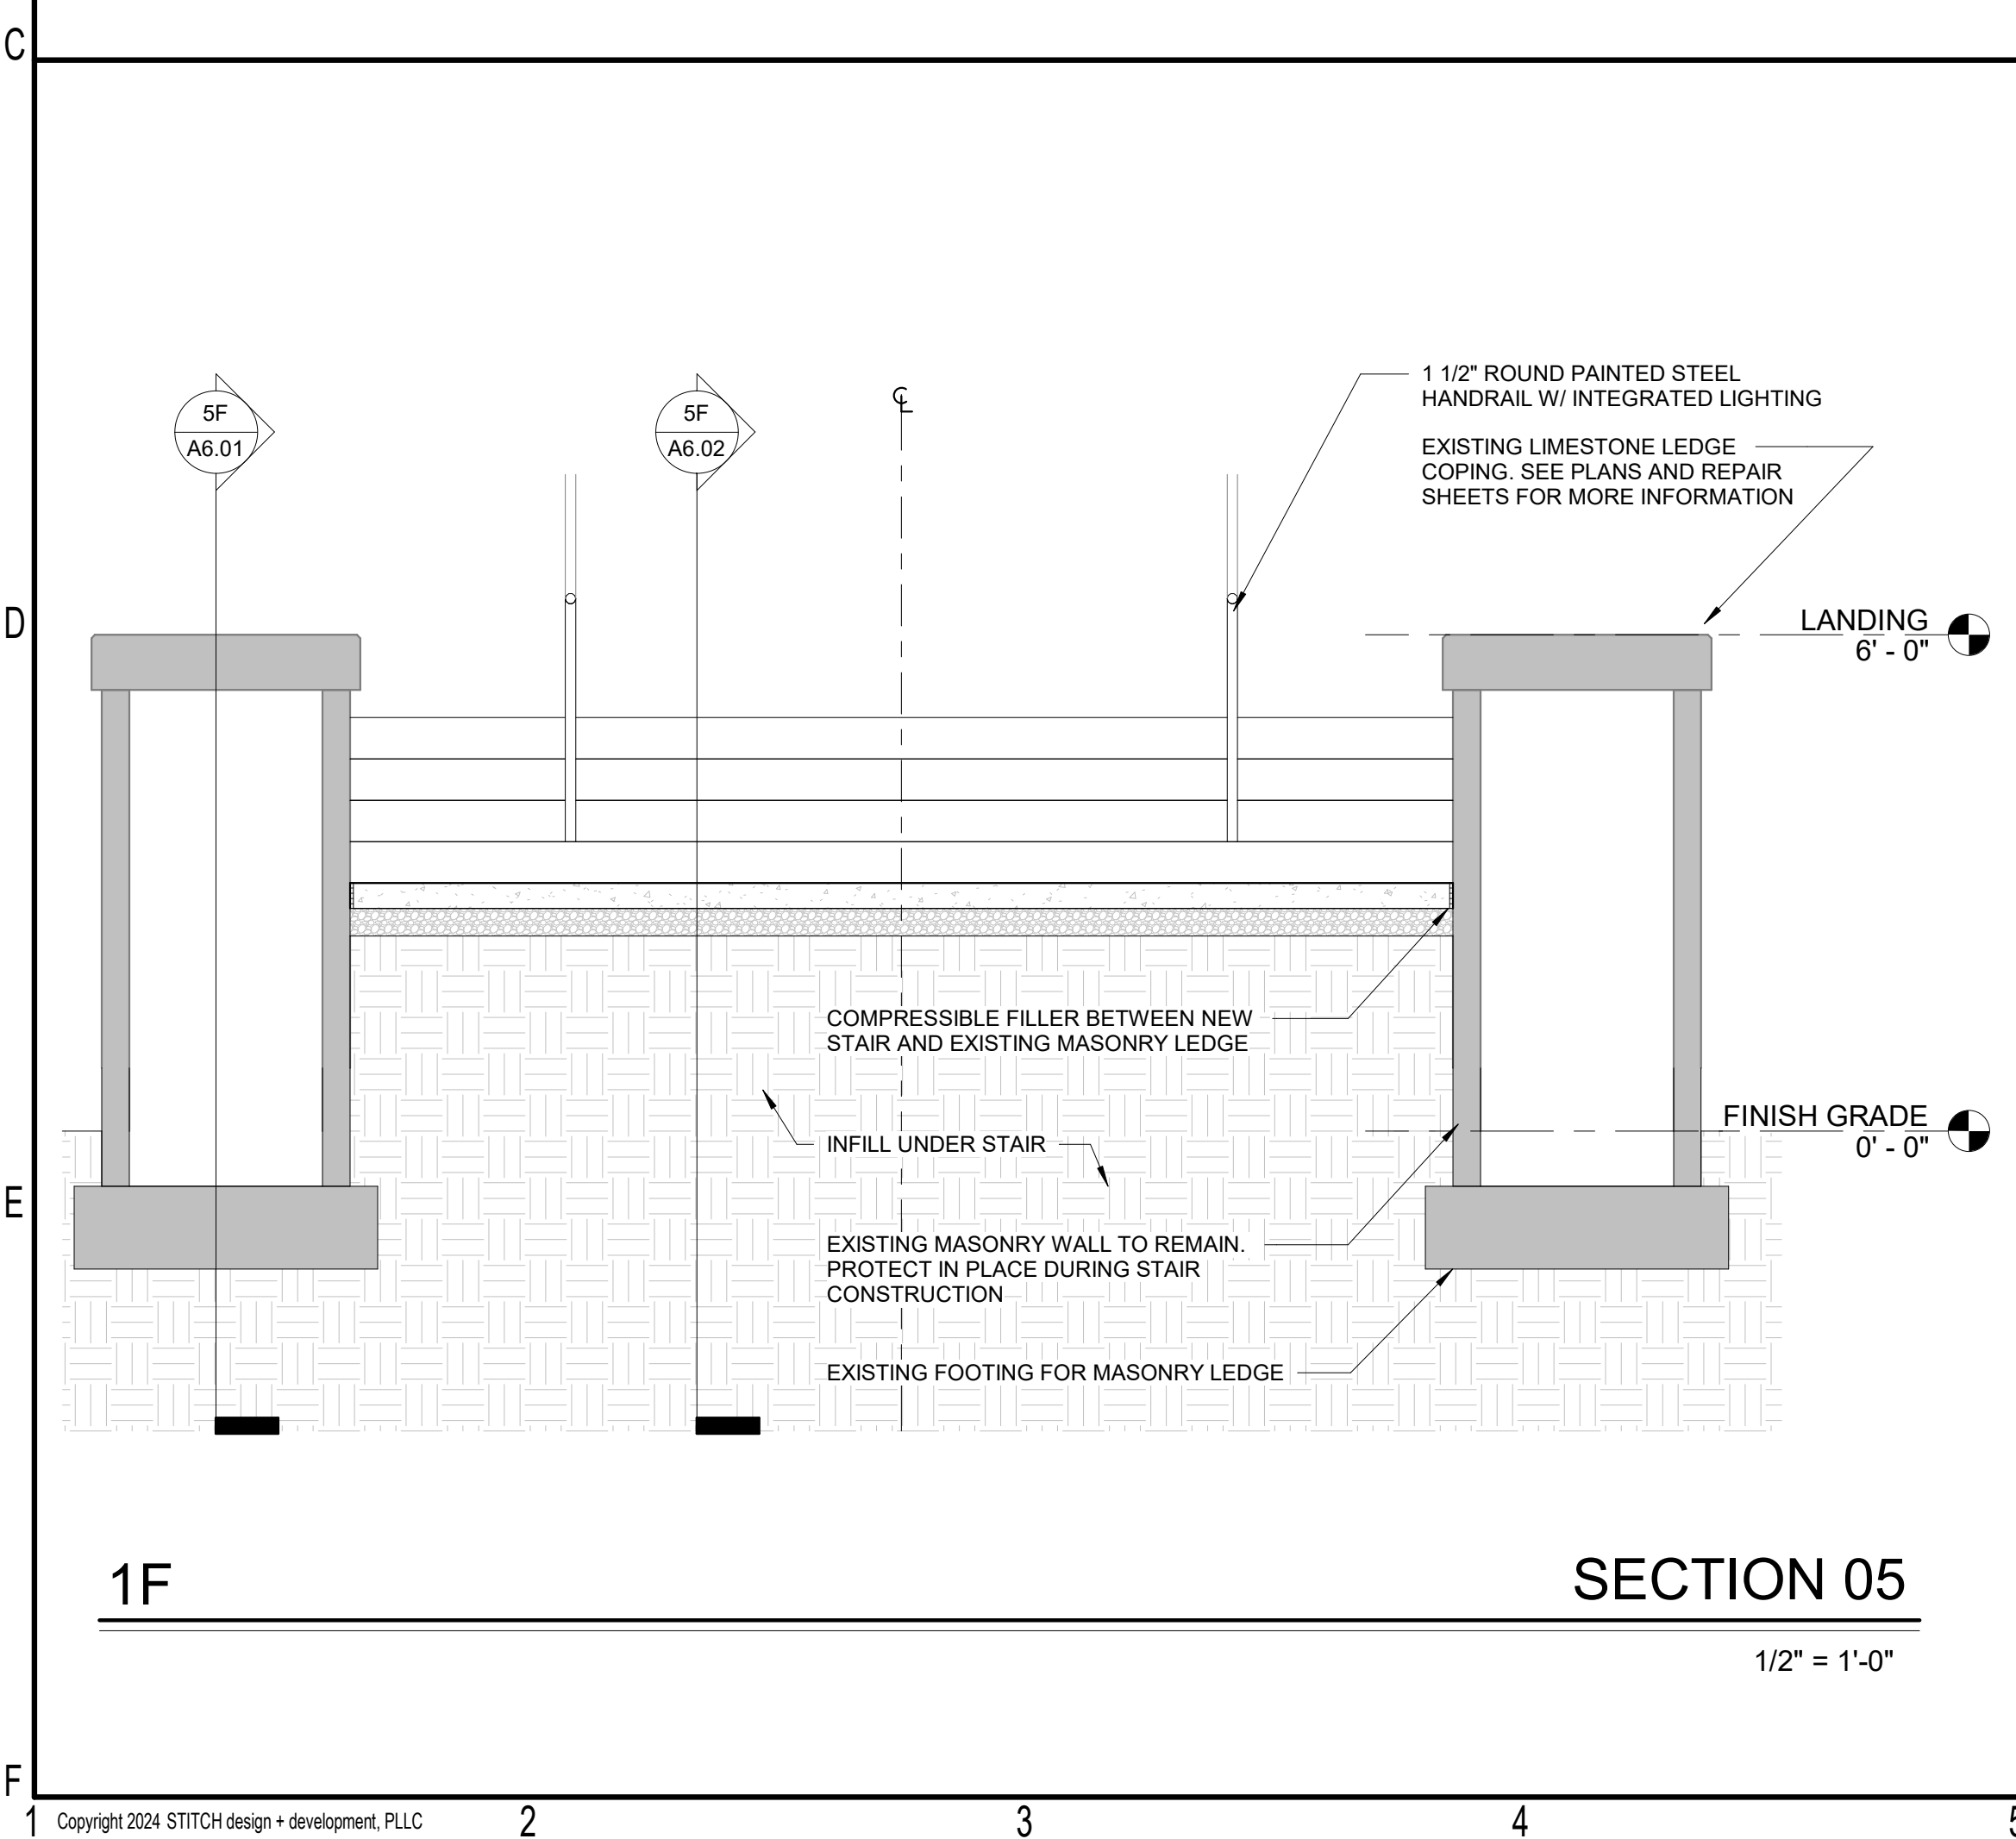
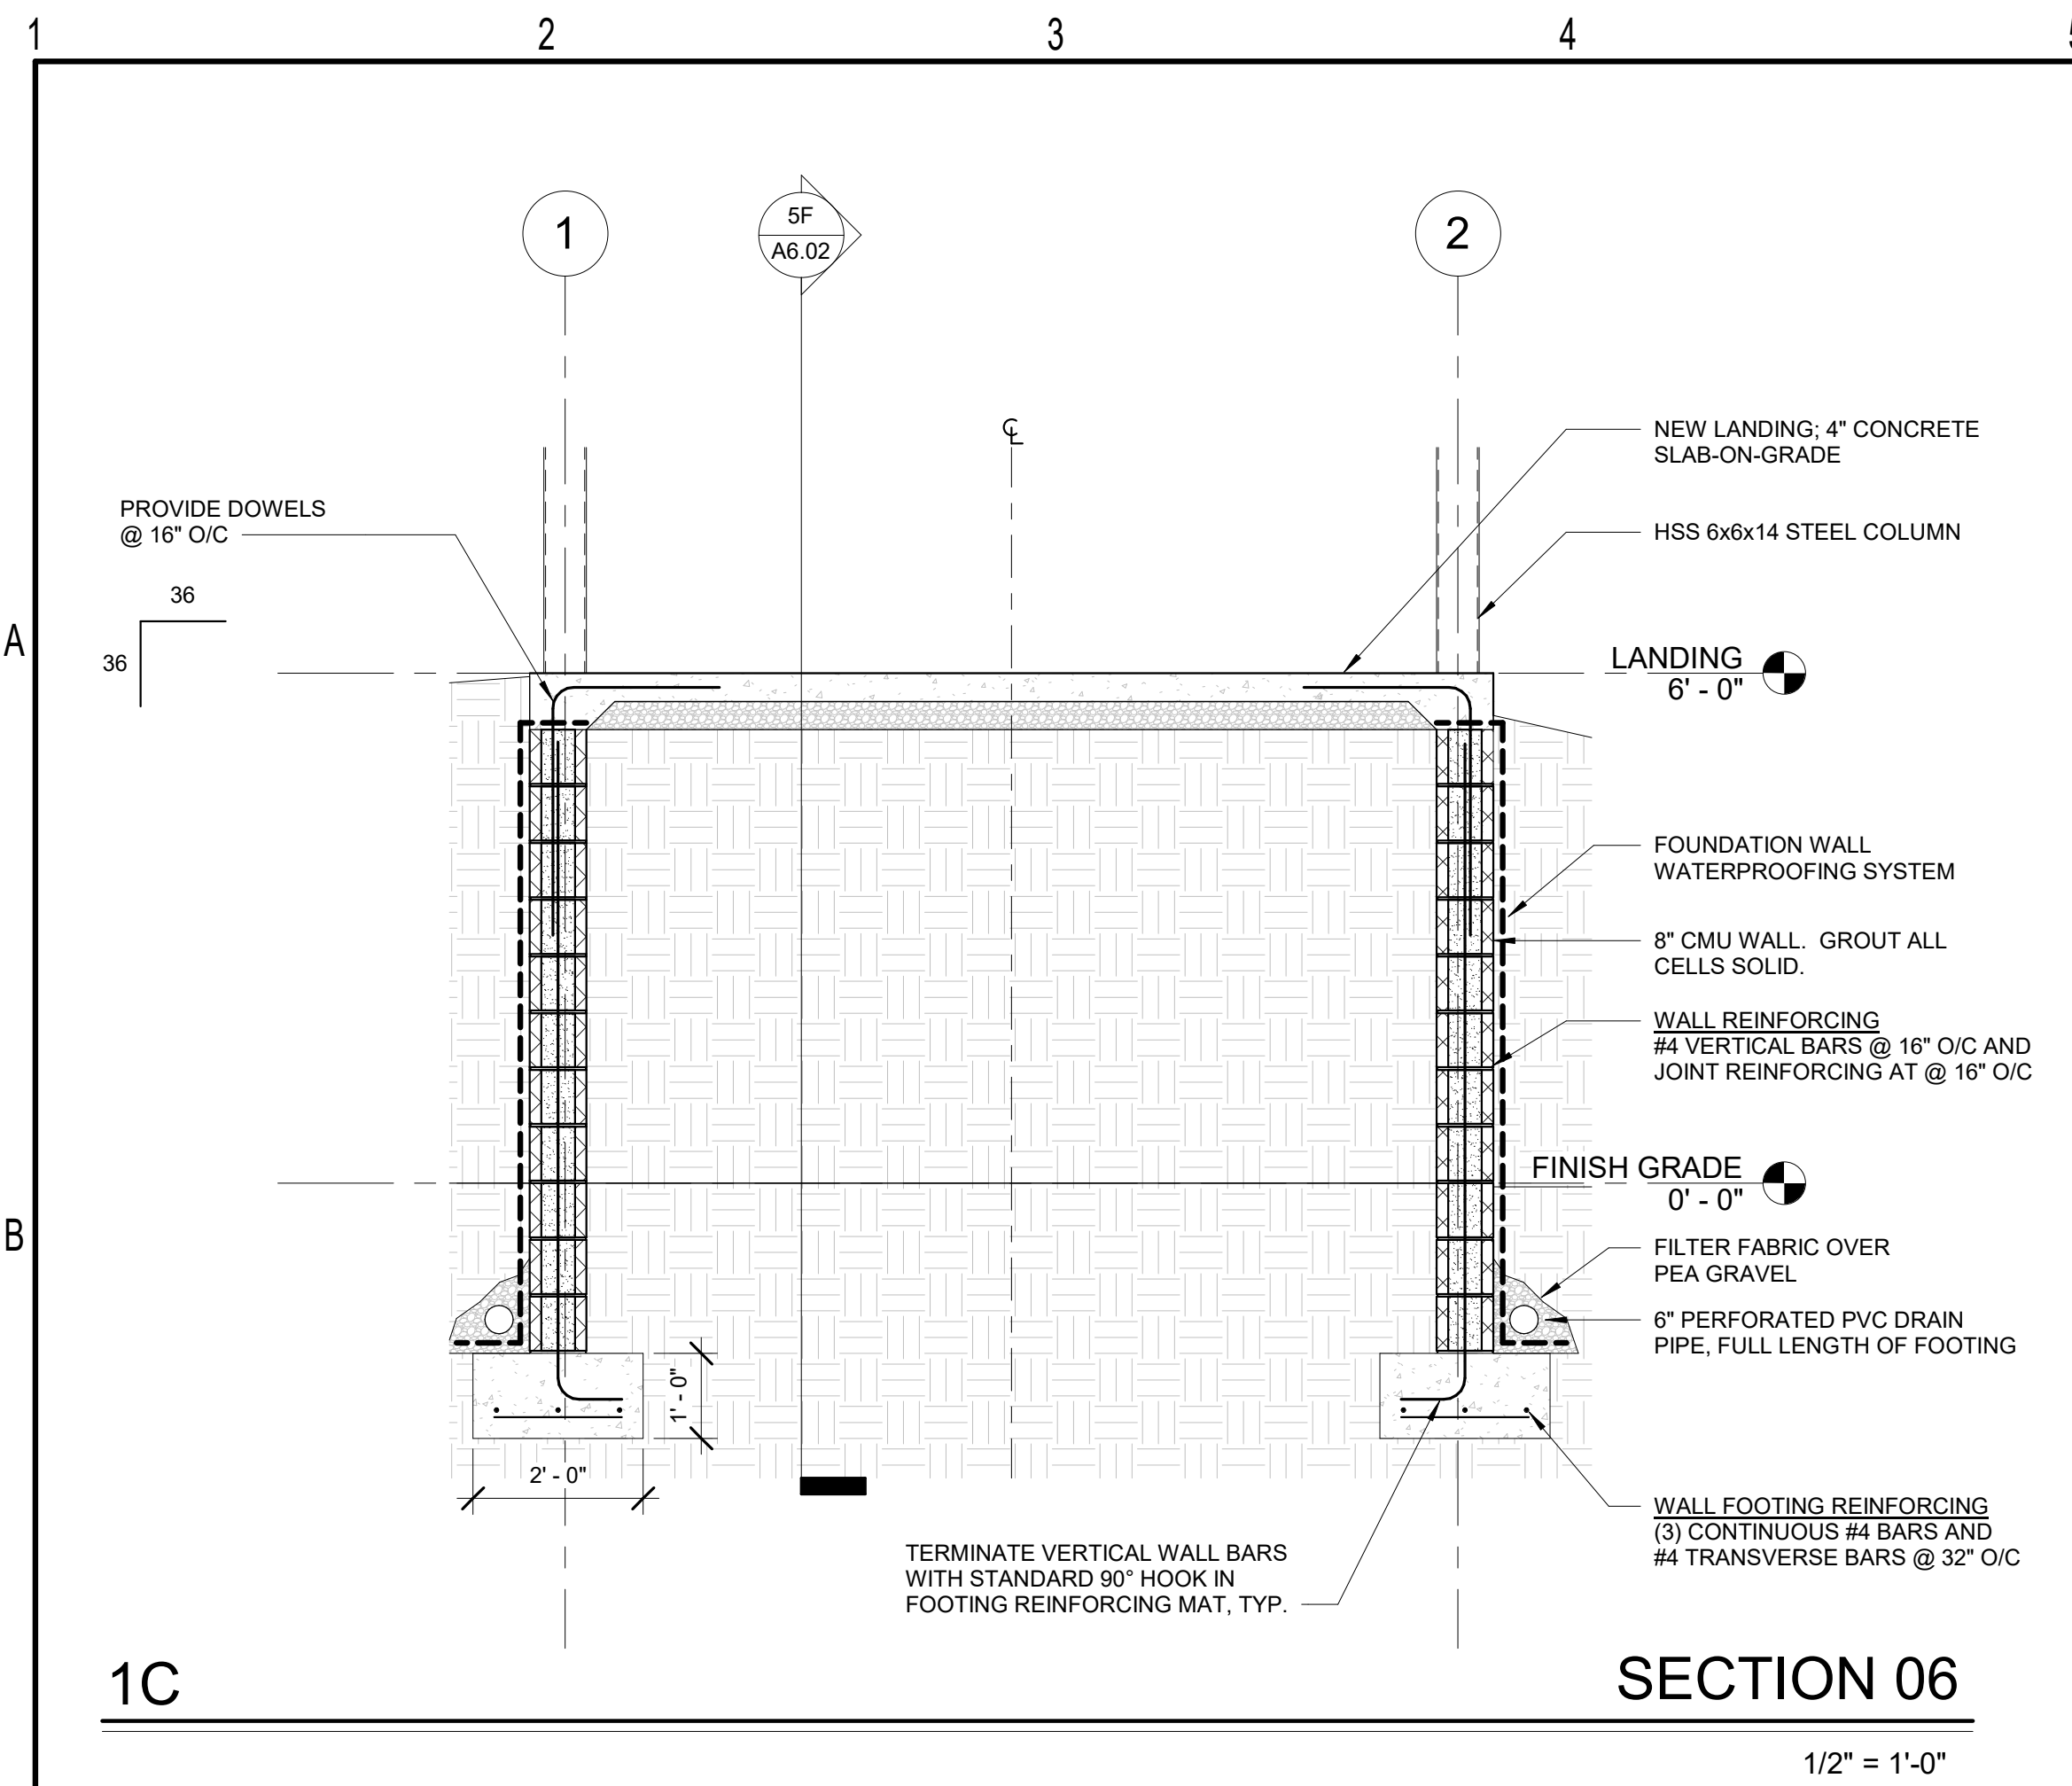
Revisions		
No.	Description	Date

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sheet no.:

A1.01

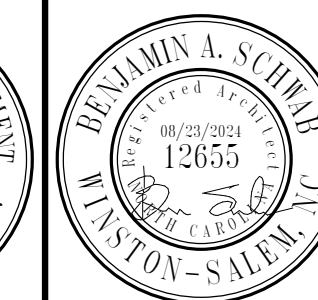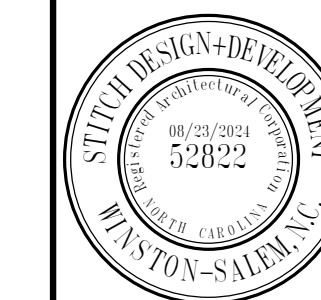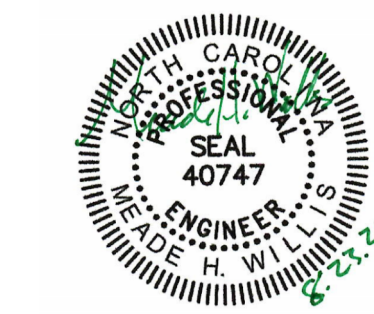

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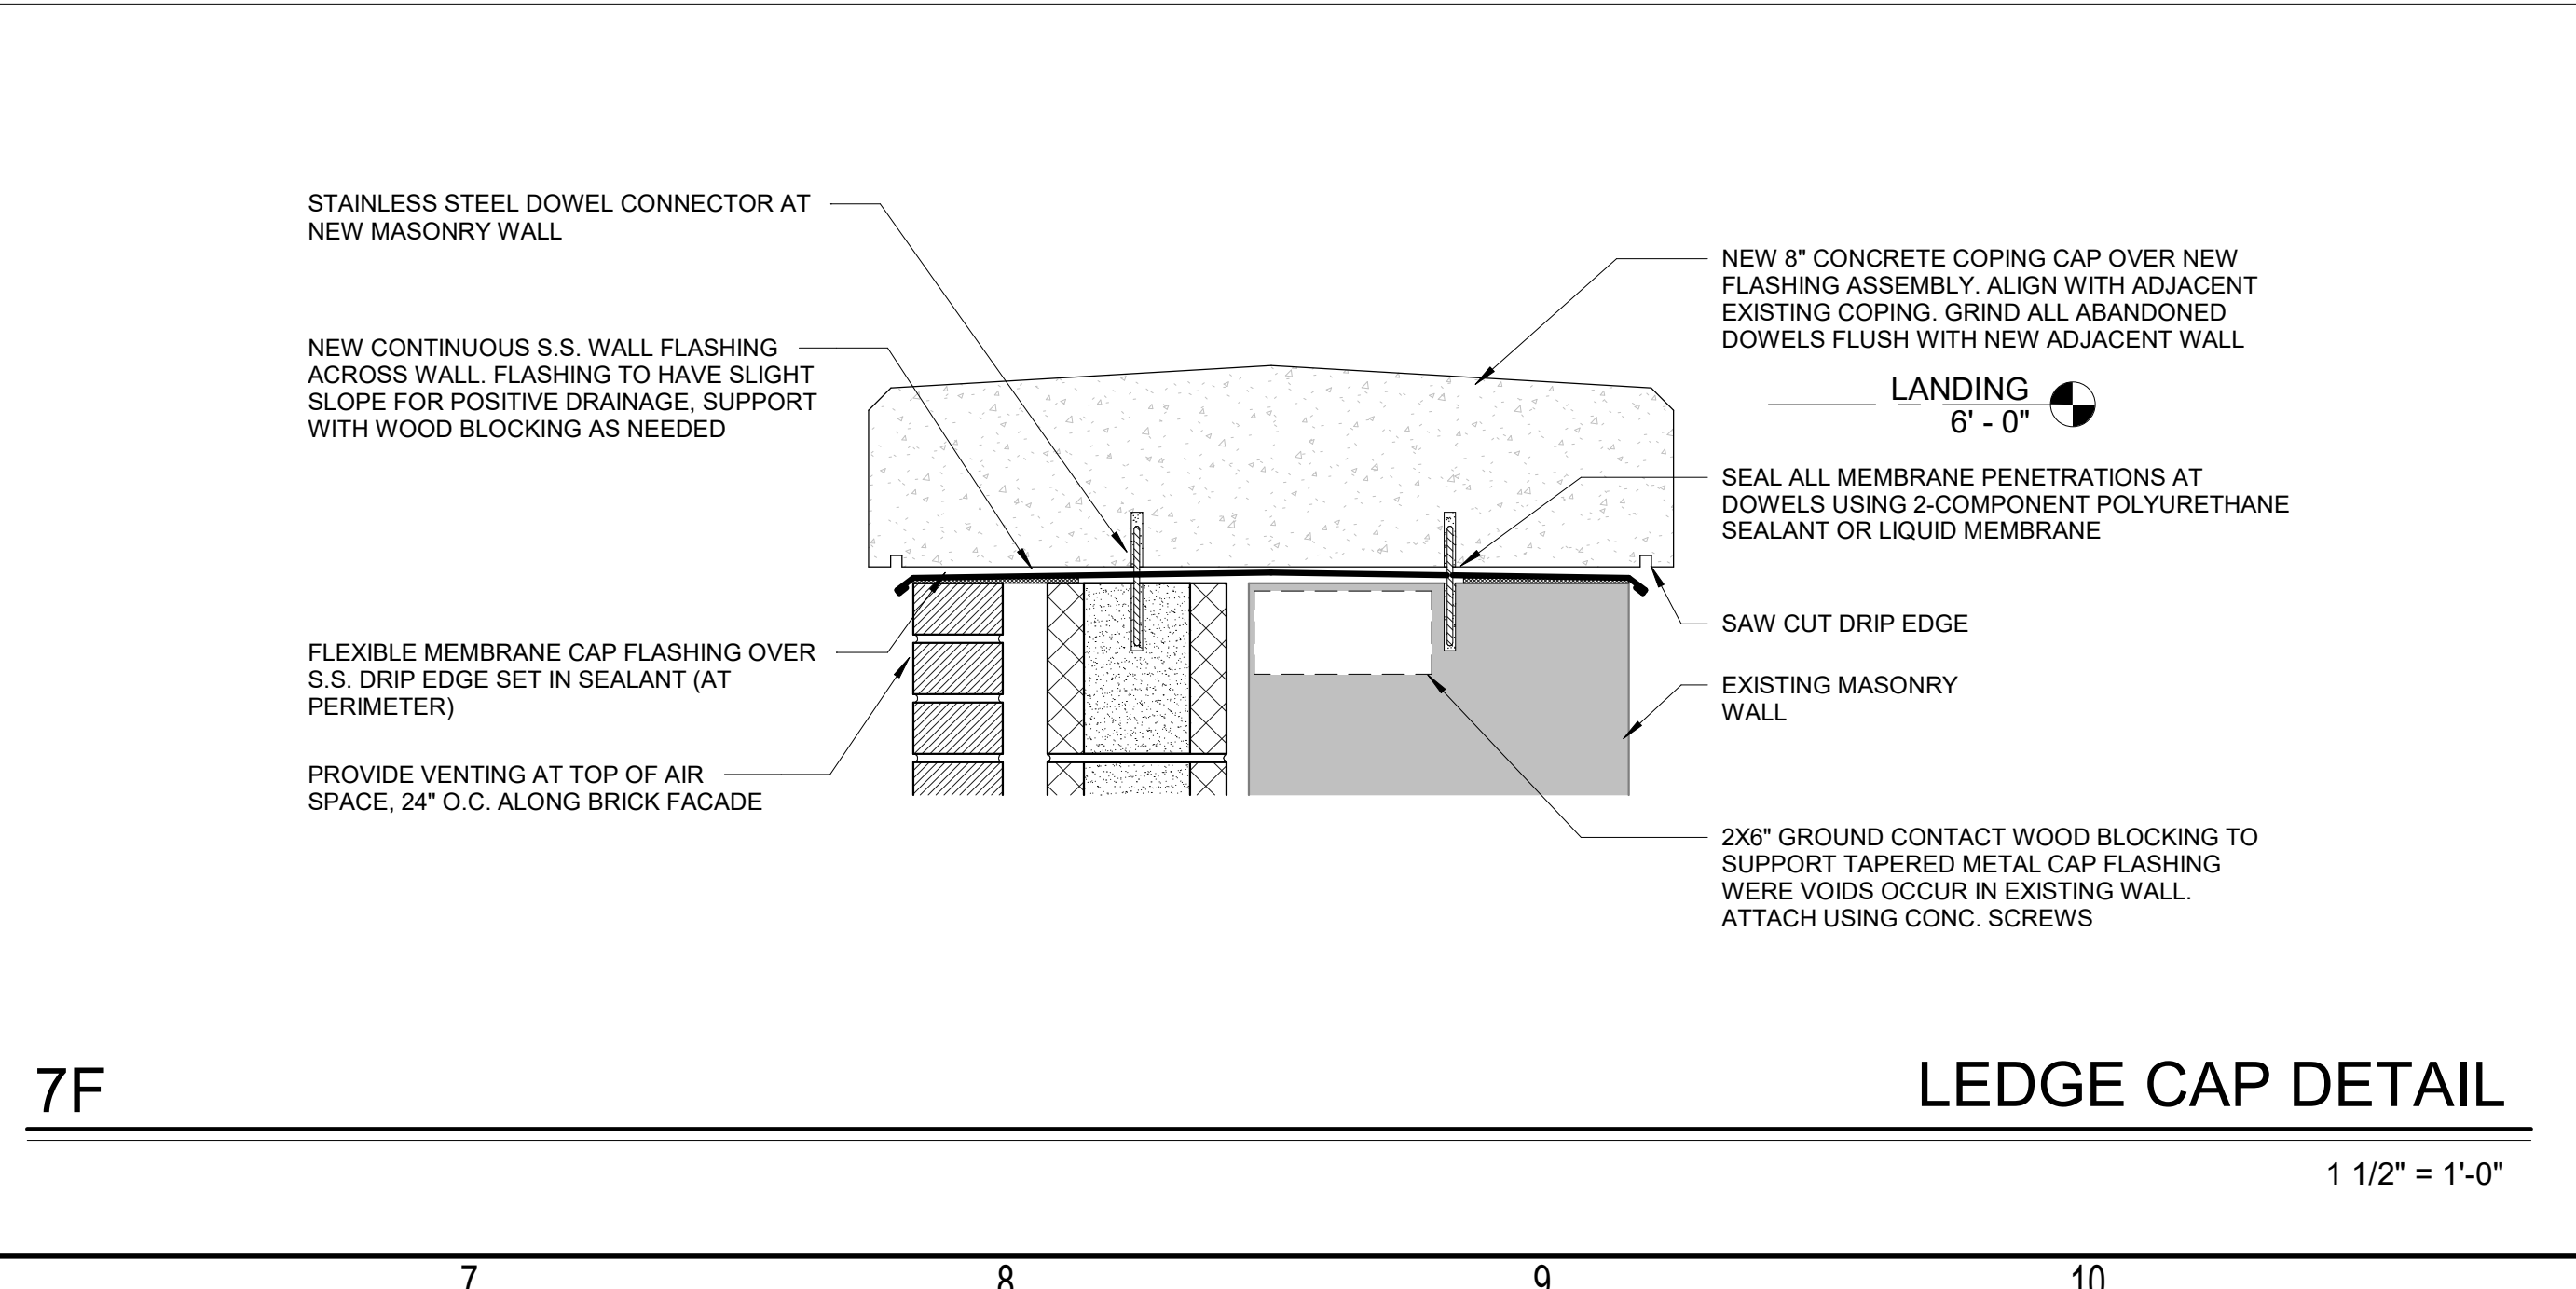
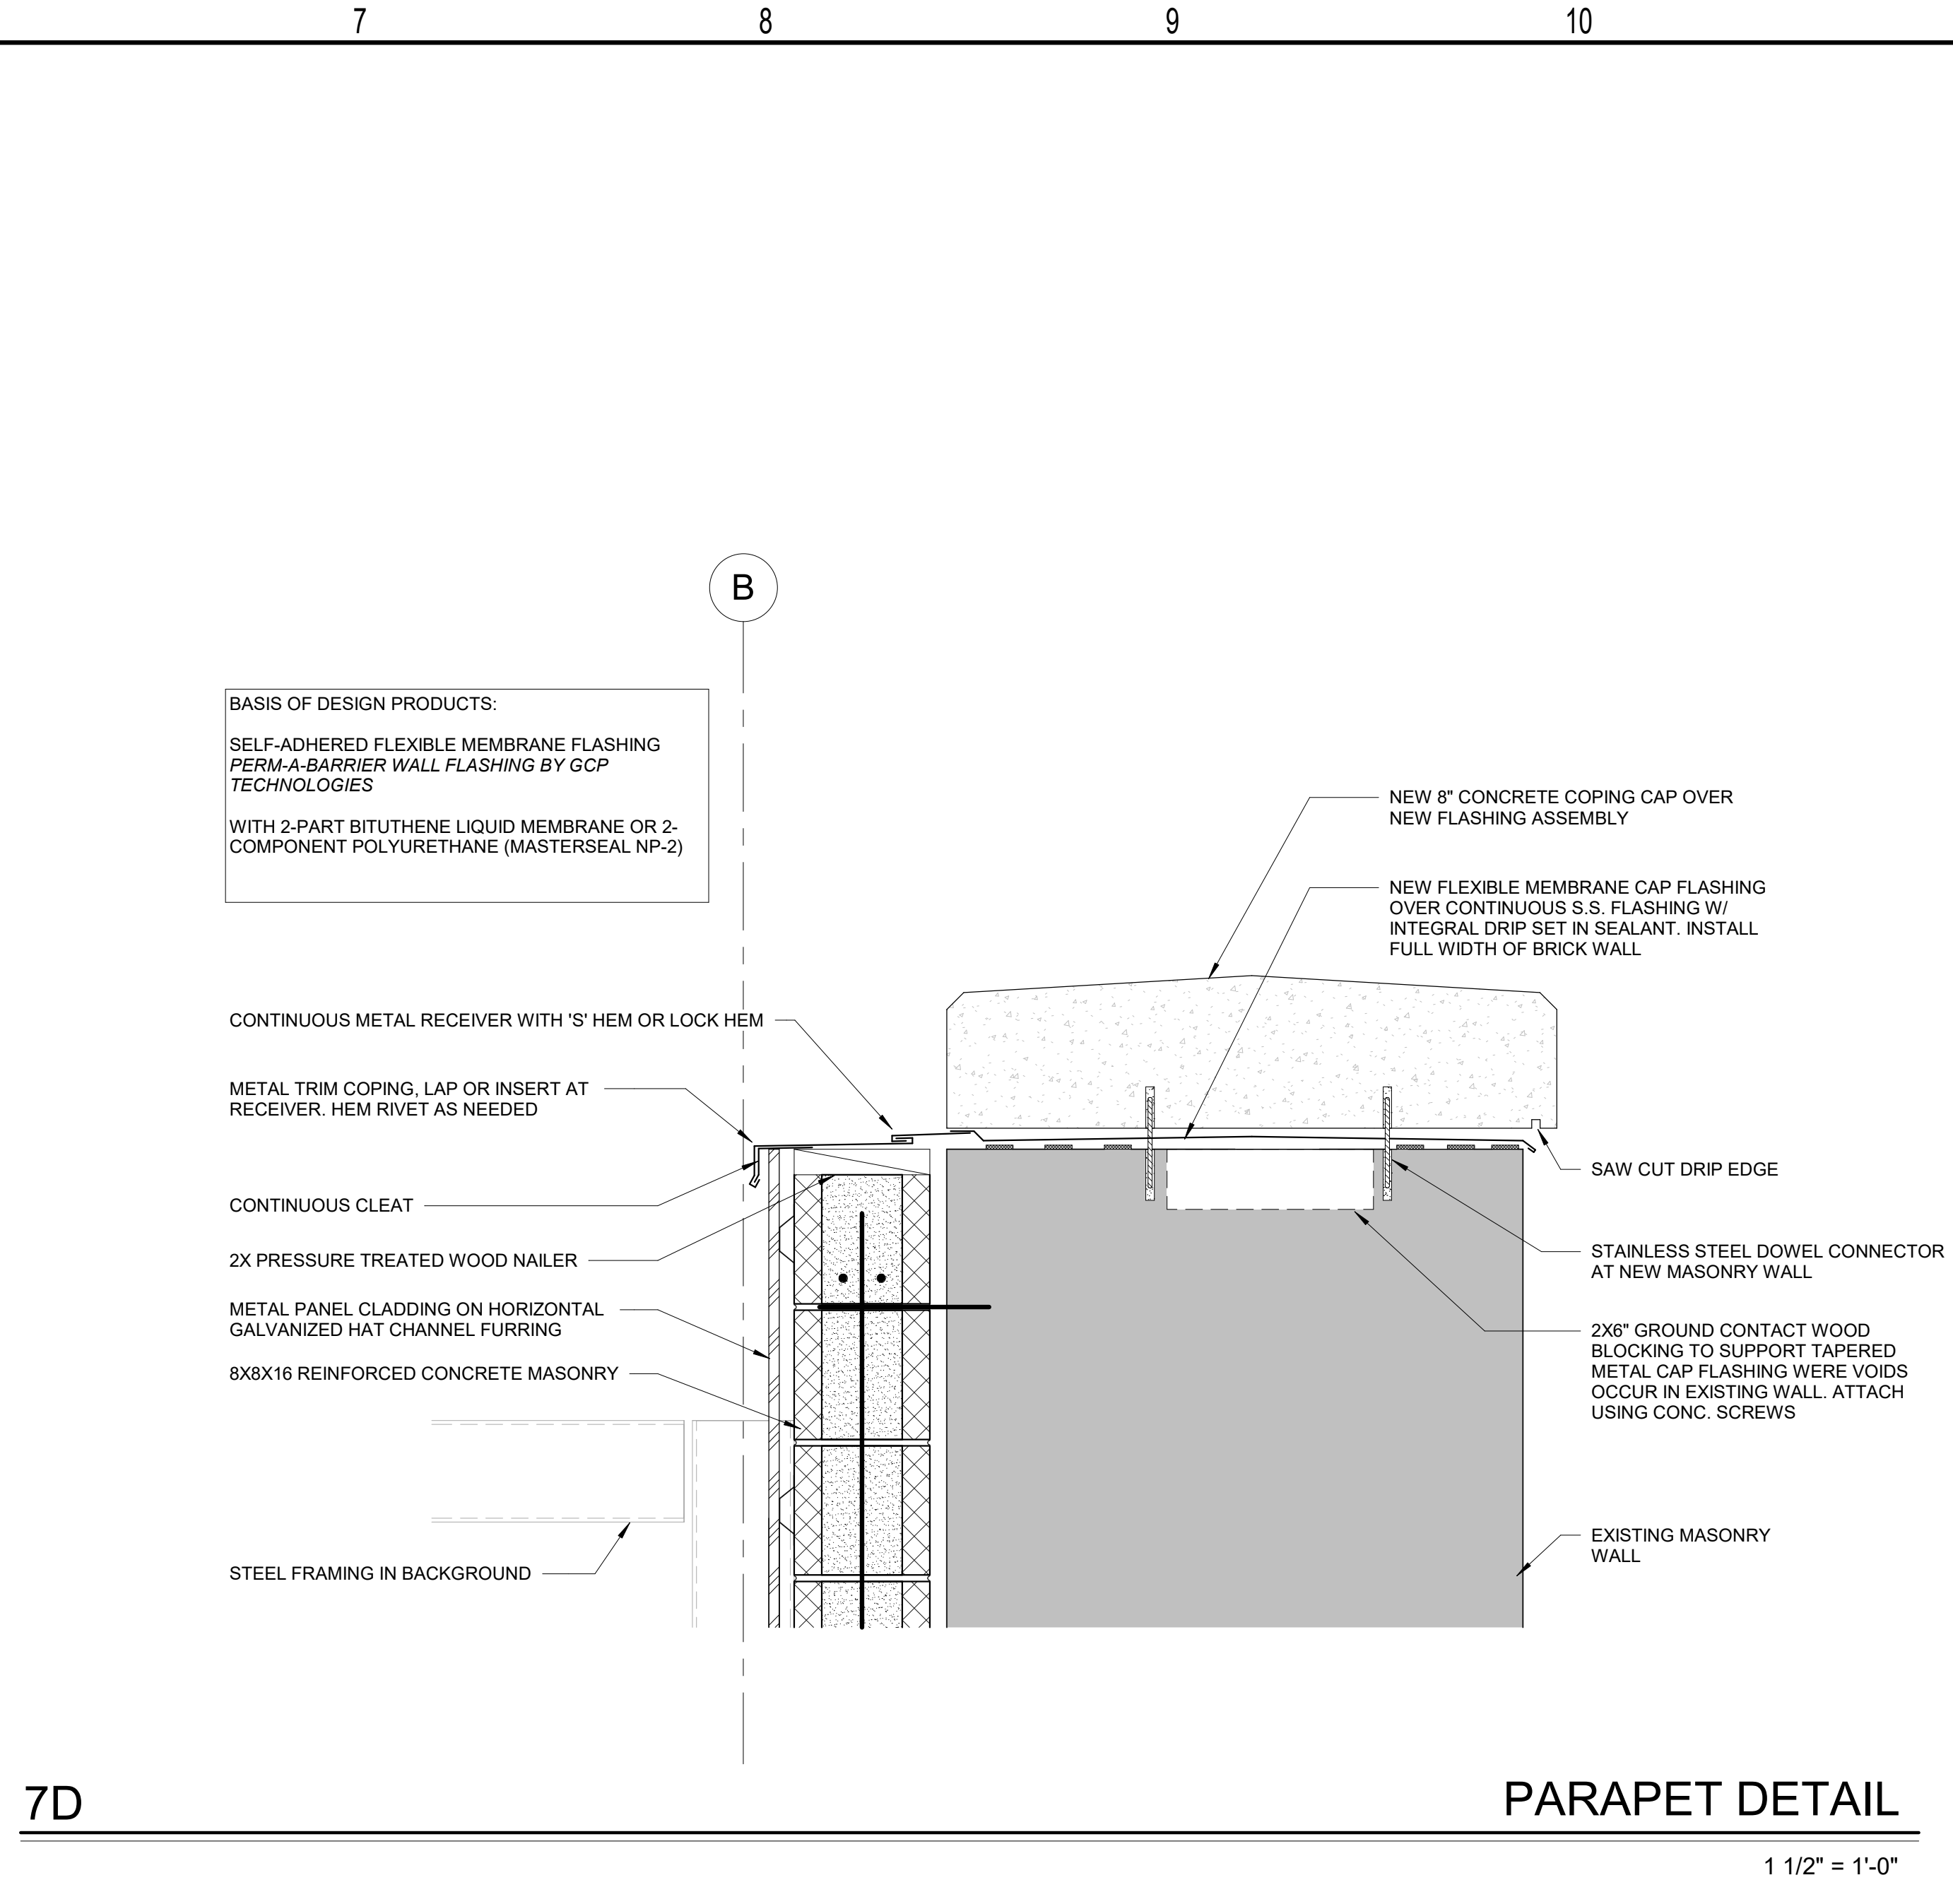
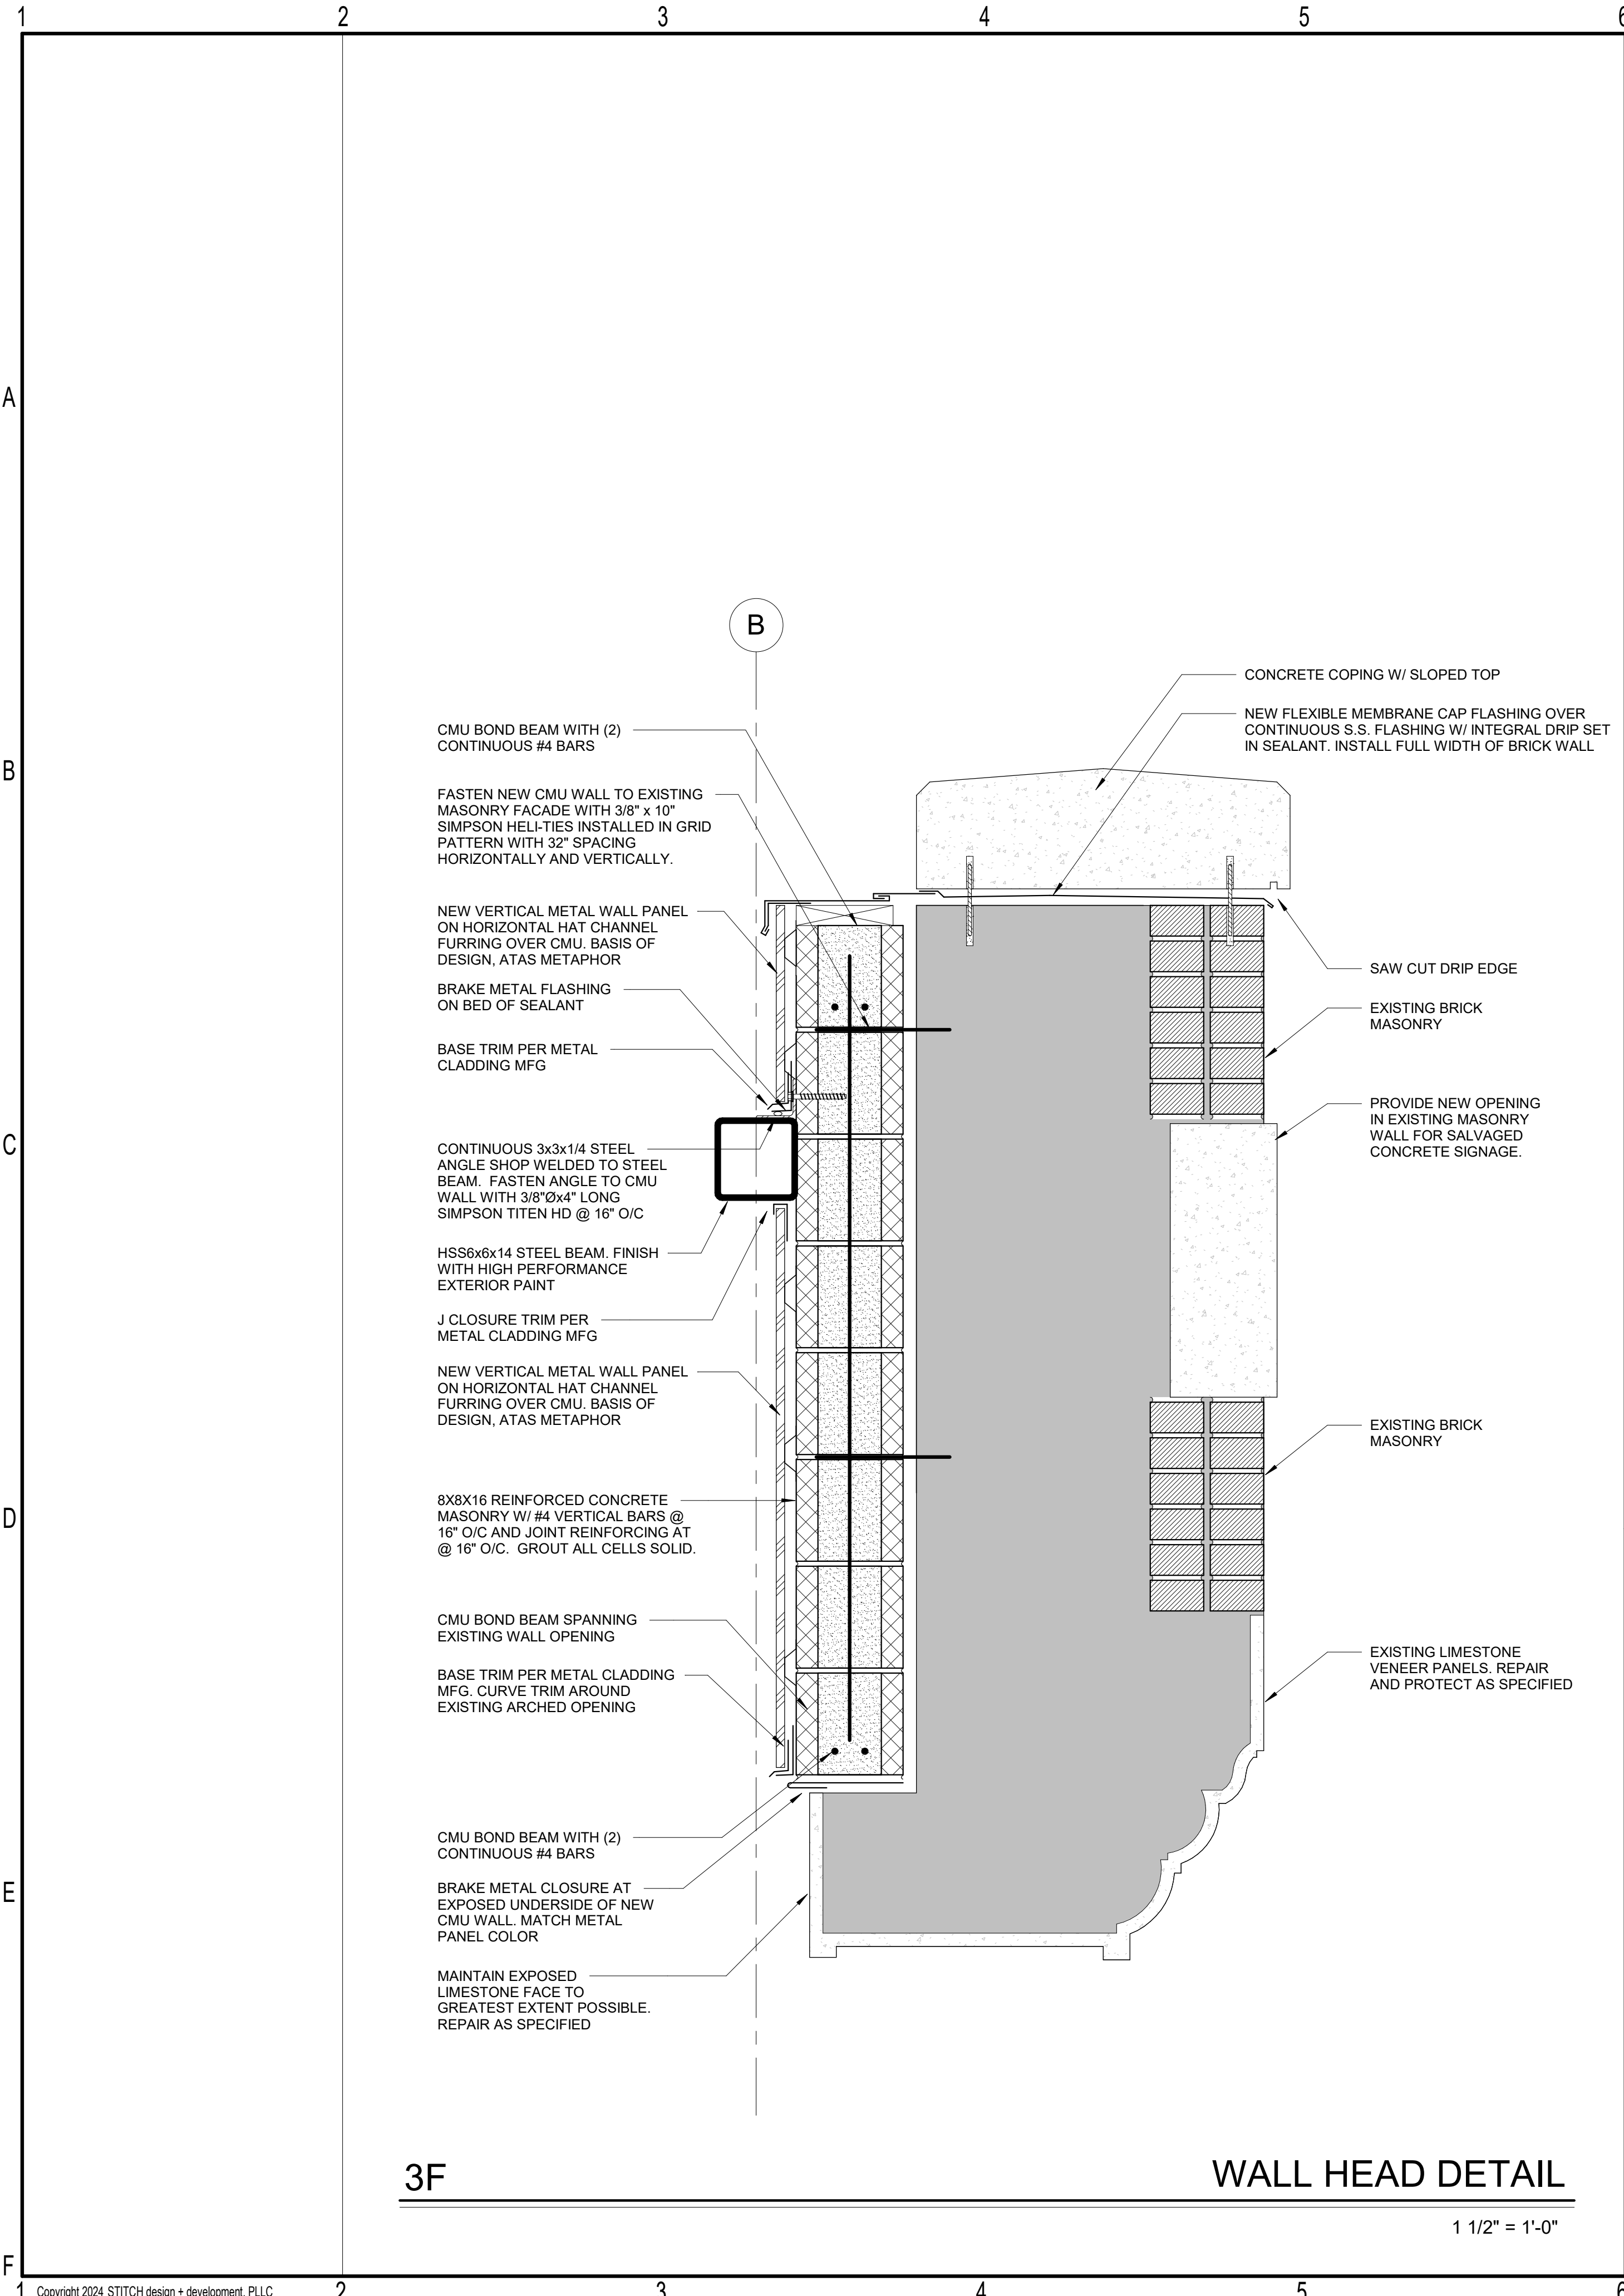
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sheet no.: **A6.02**



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STITCH DESIGN + DEVELOPMENT, PLLC
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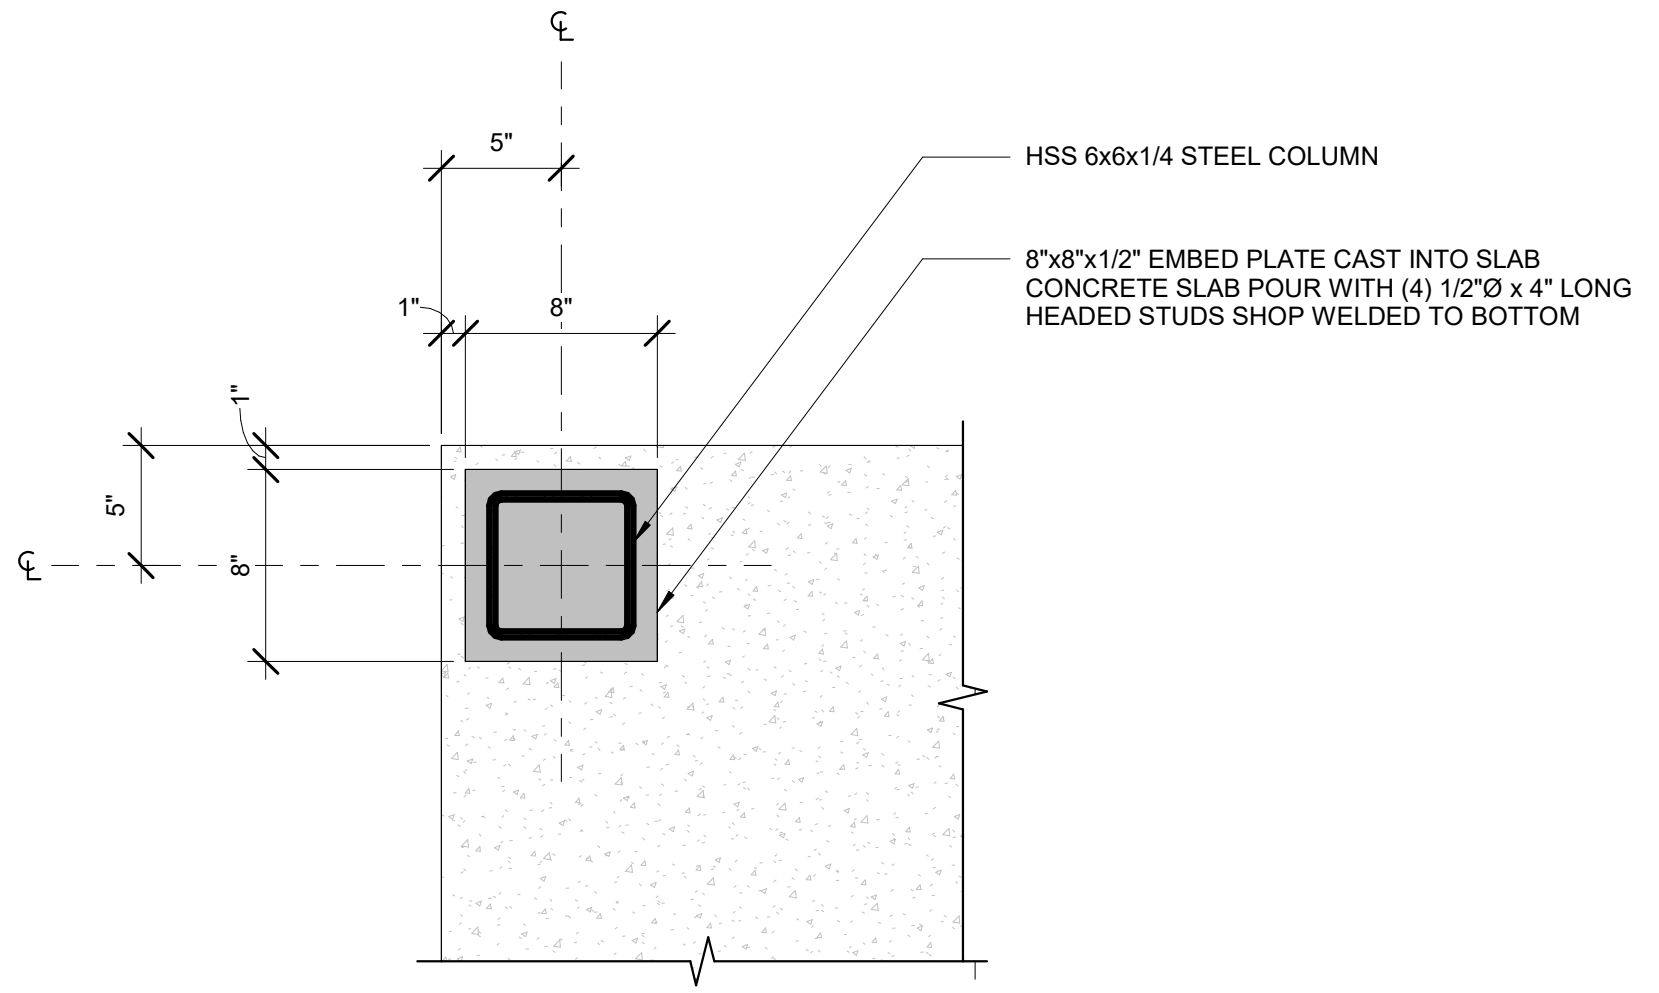
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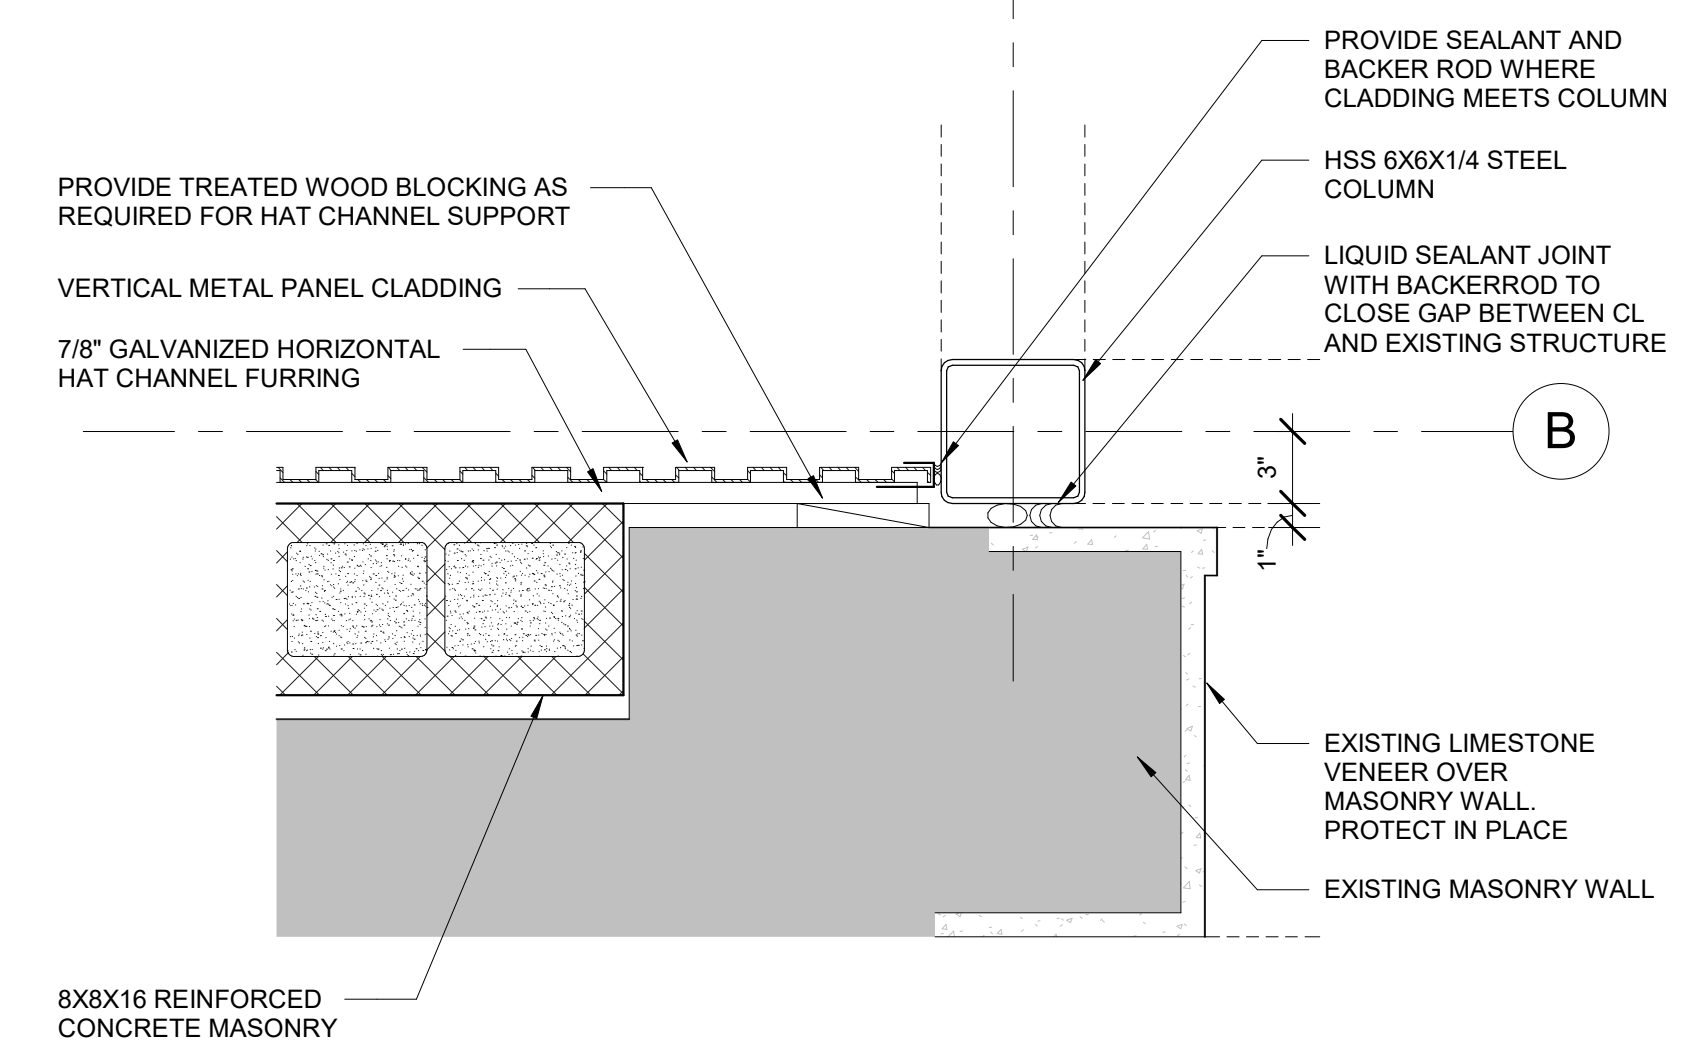
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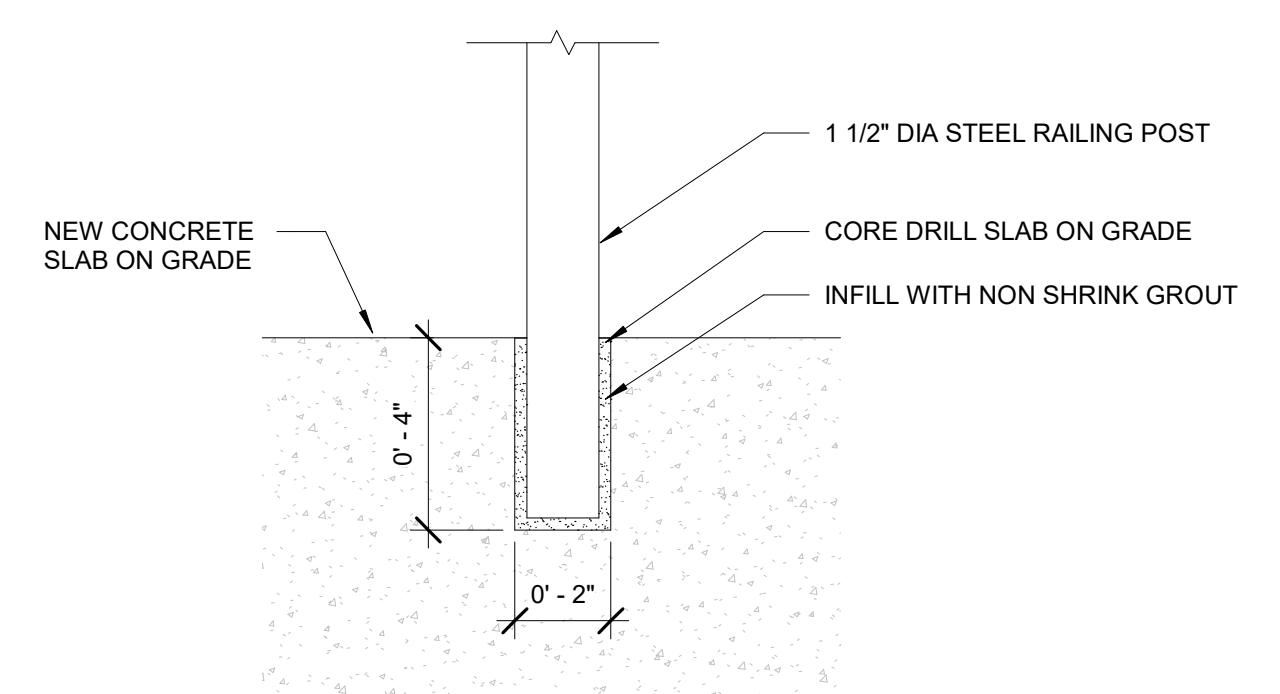


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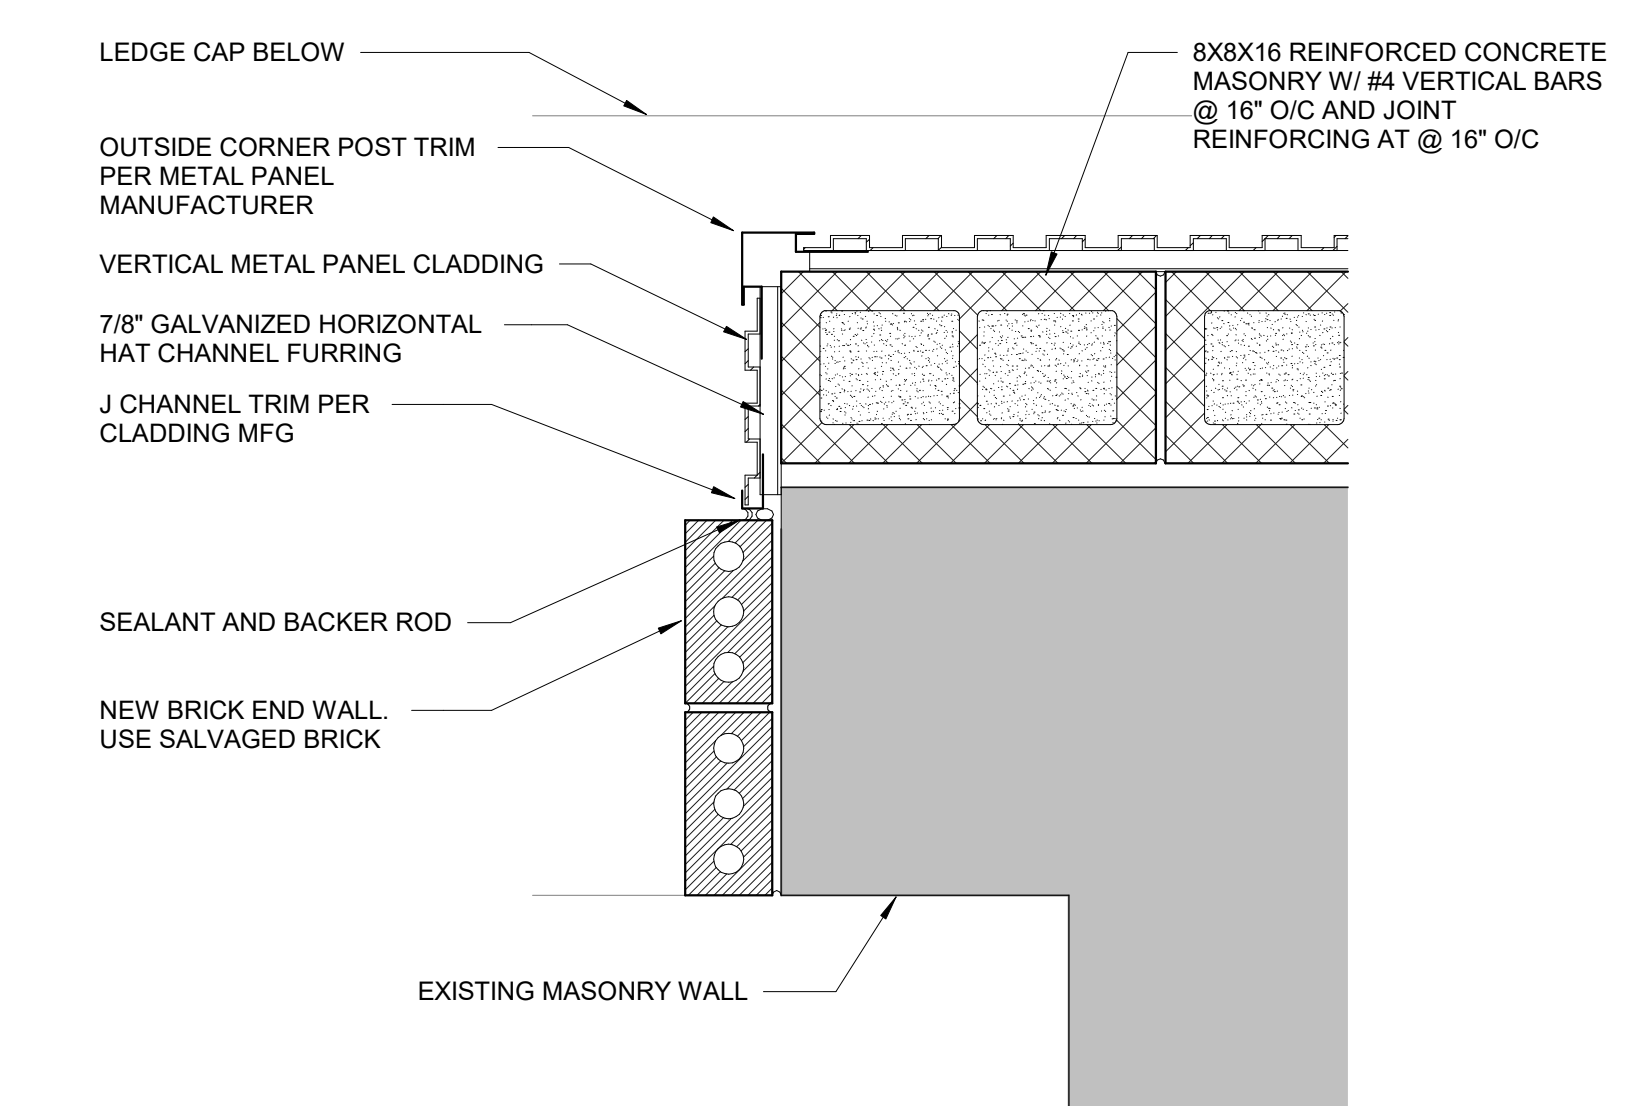
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UV EXPOSED LIQUID SEALANT (NOT IN CONTACT WITH ASPHALT-BASED MATERIAL) - DOWSIL 790 SILICONE SEALANT



8C PLAN DETAIL 02
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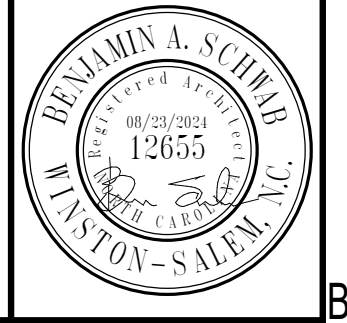
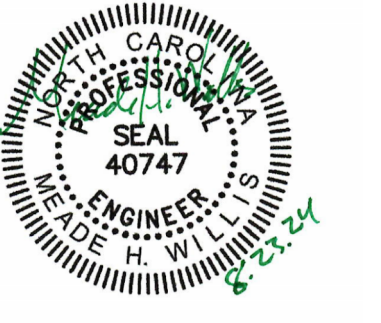
5F HANDRAIL SECTION DETAIL
3" = 1'-0"



8F PLAN DETAIL 01
1 1/2" = 1'-0"

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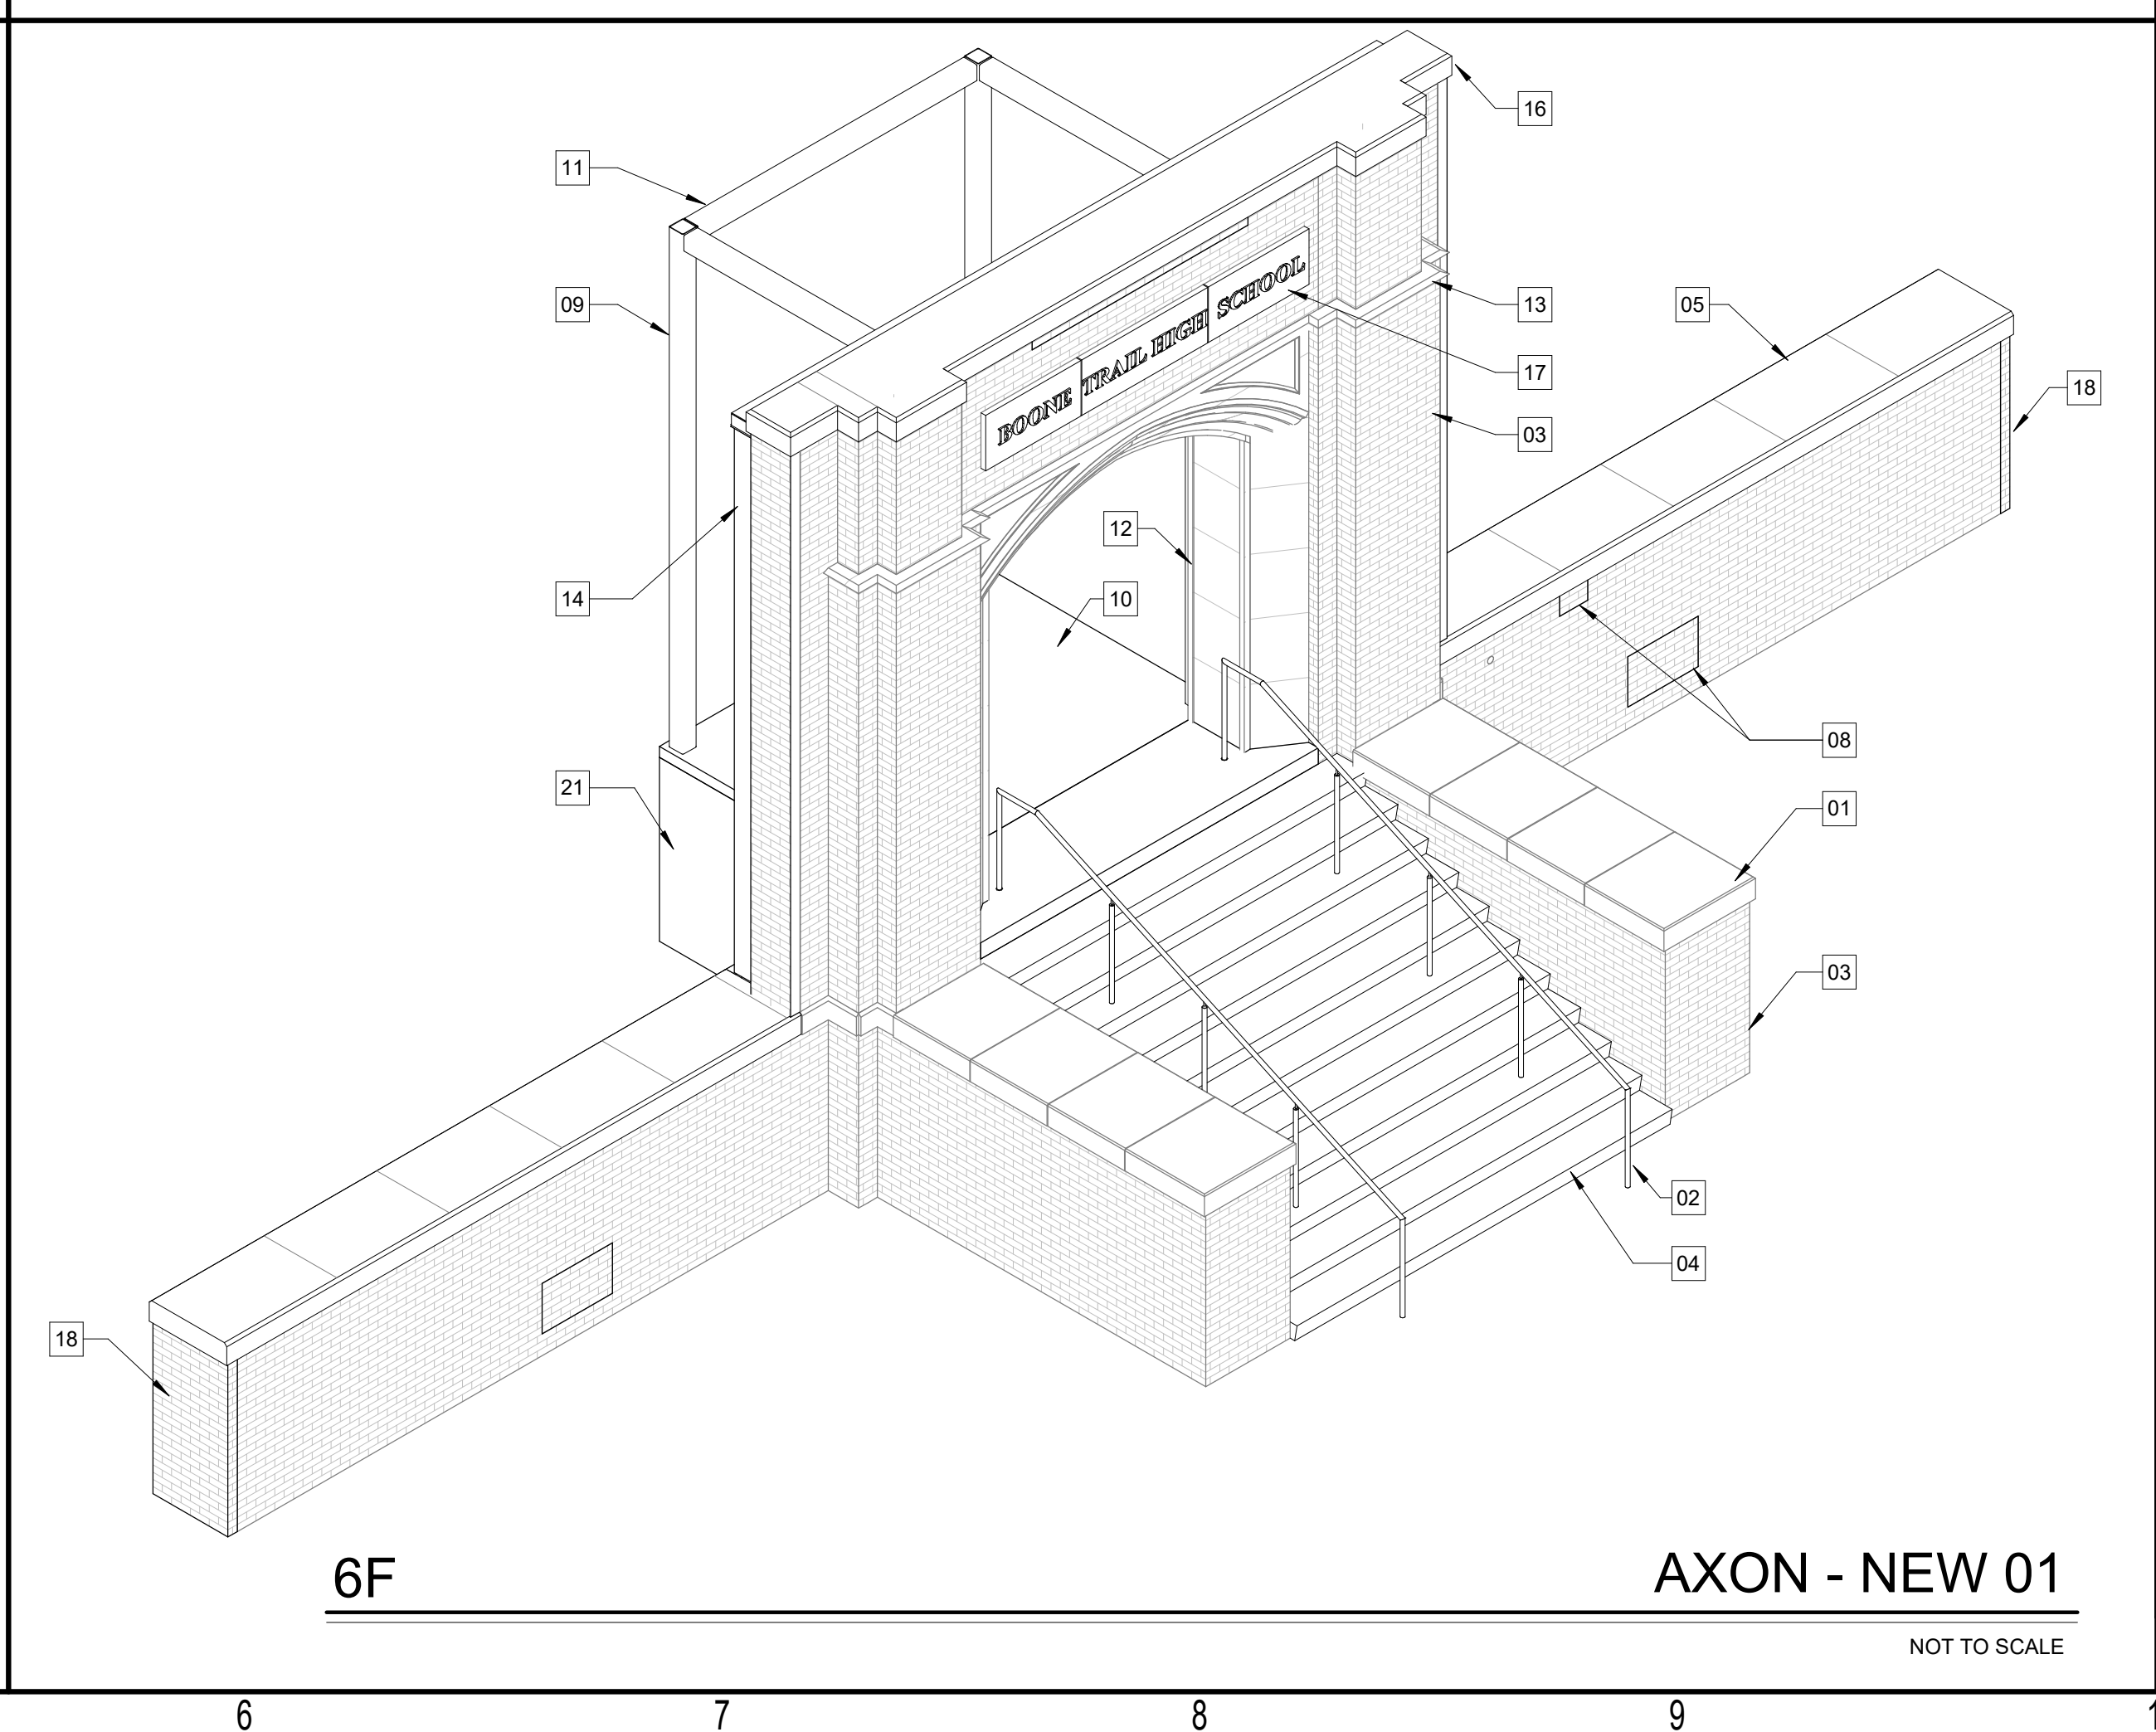
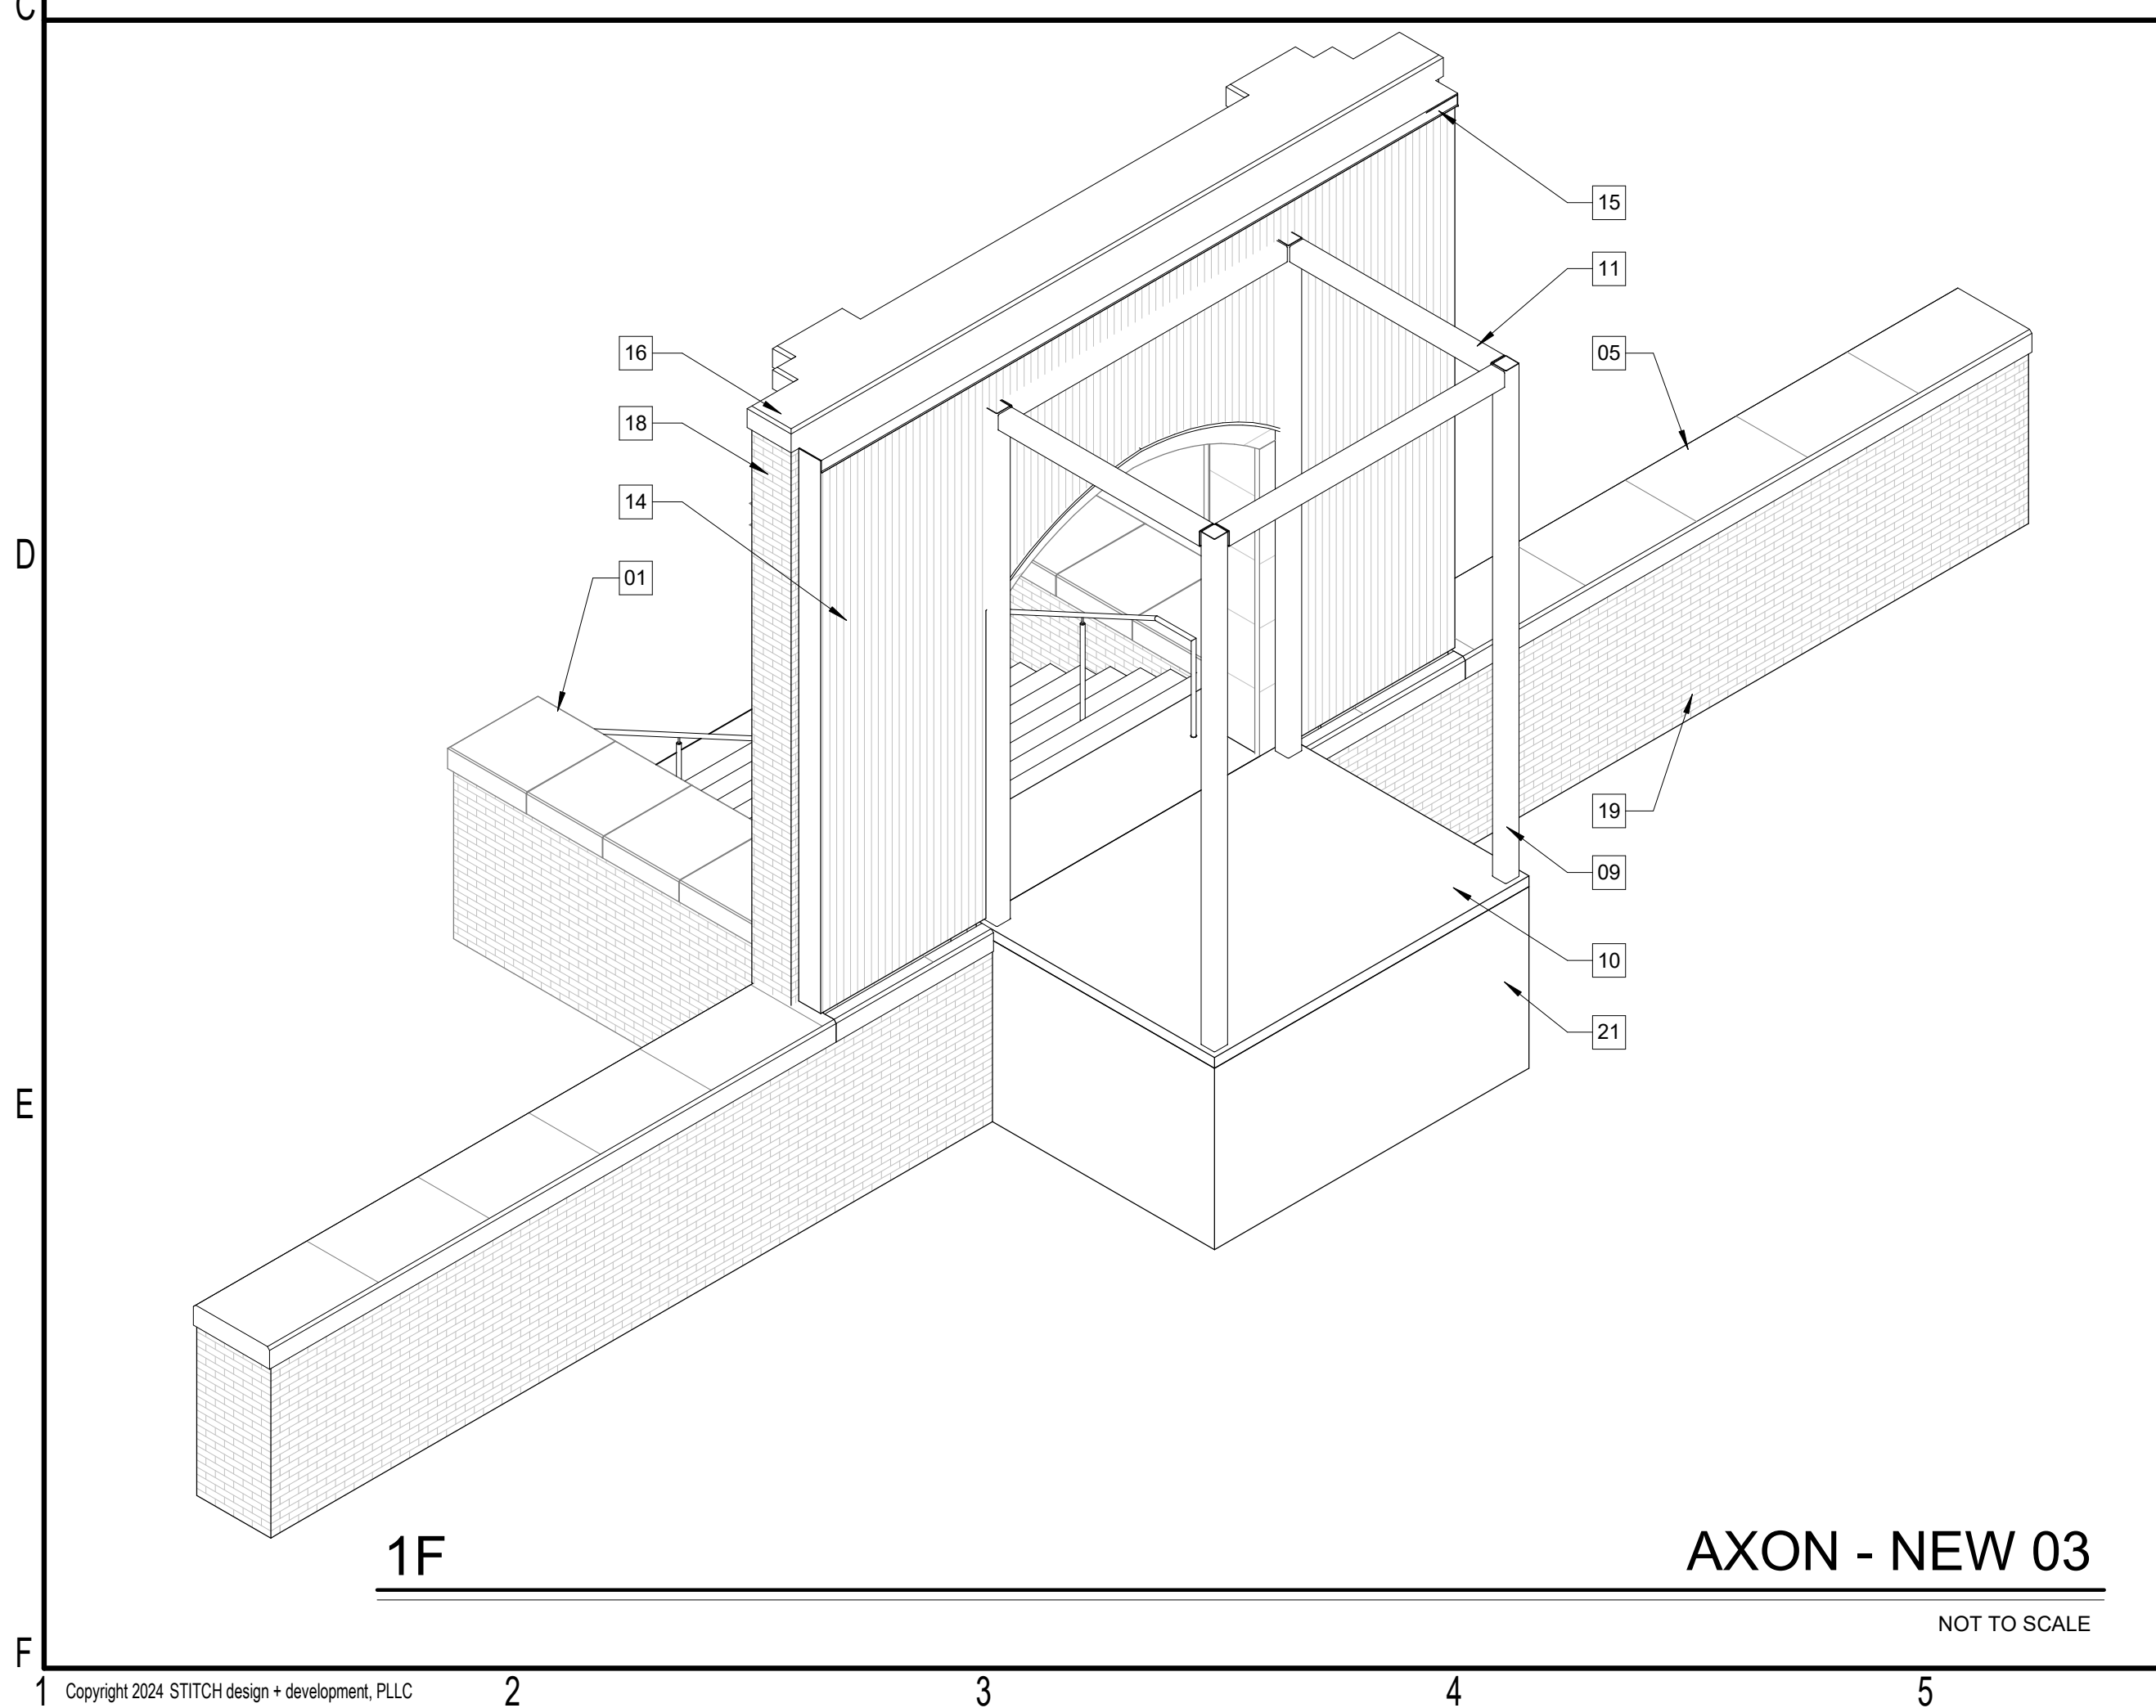
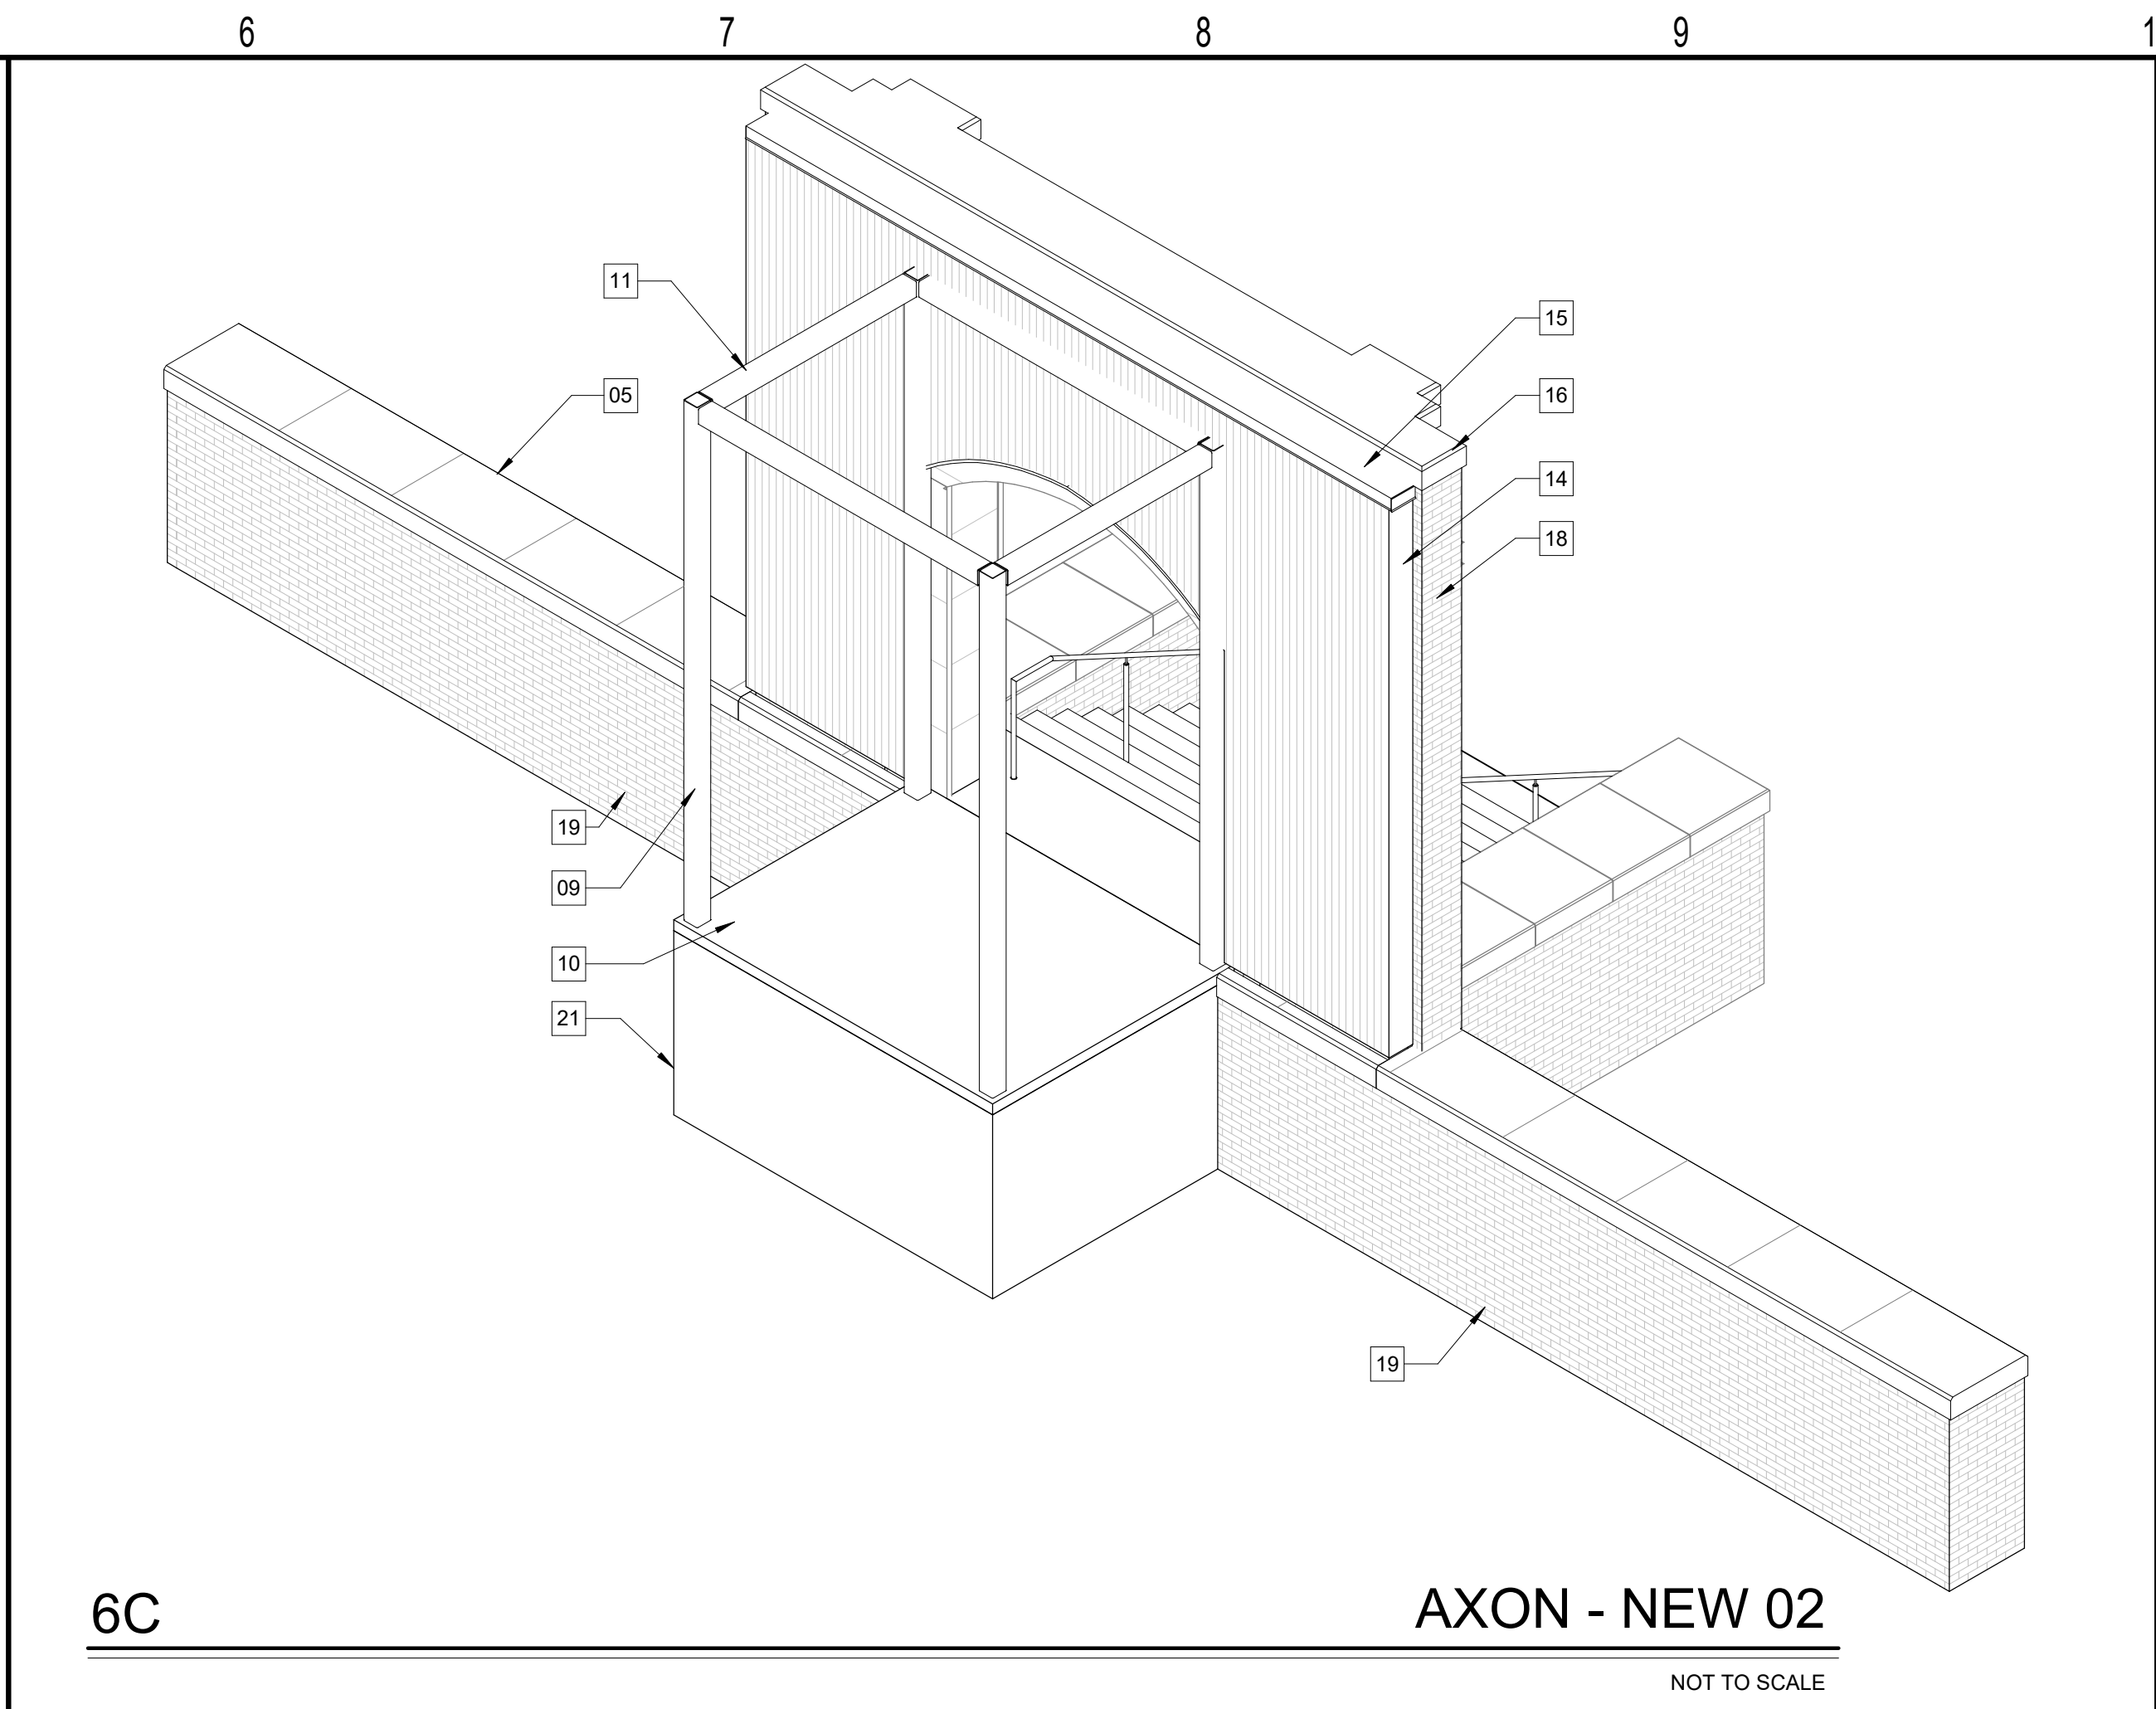
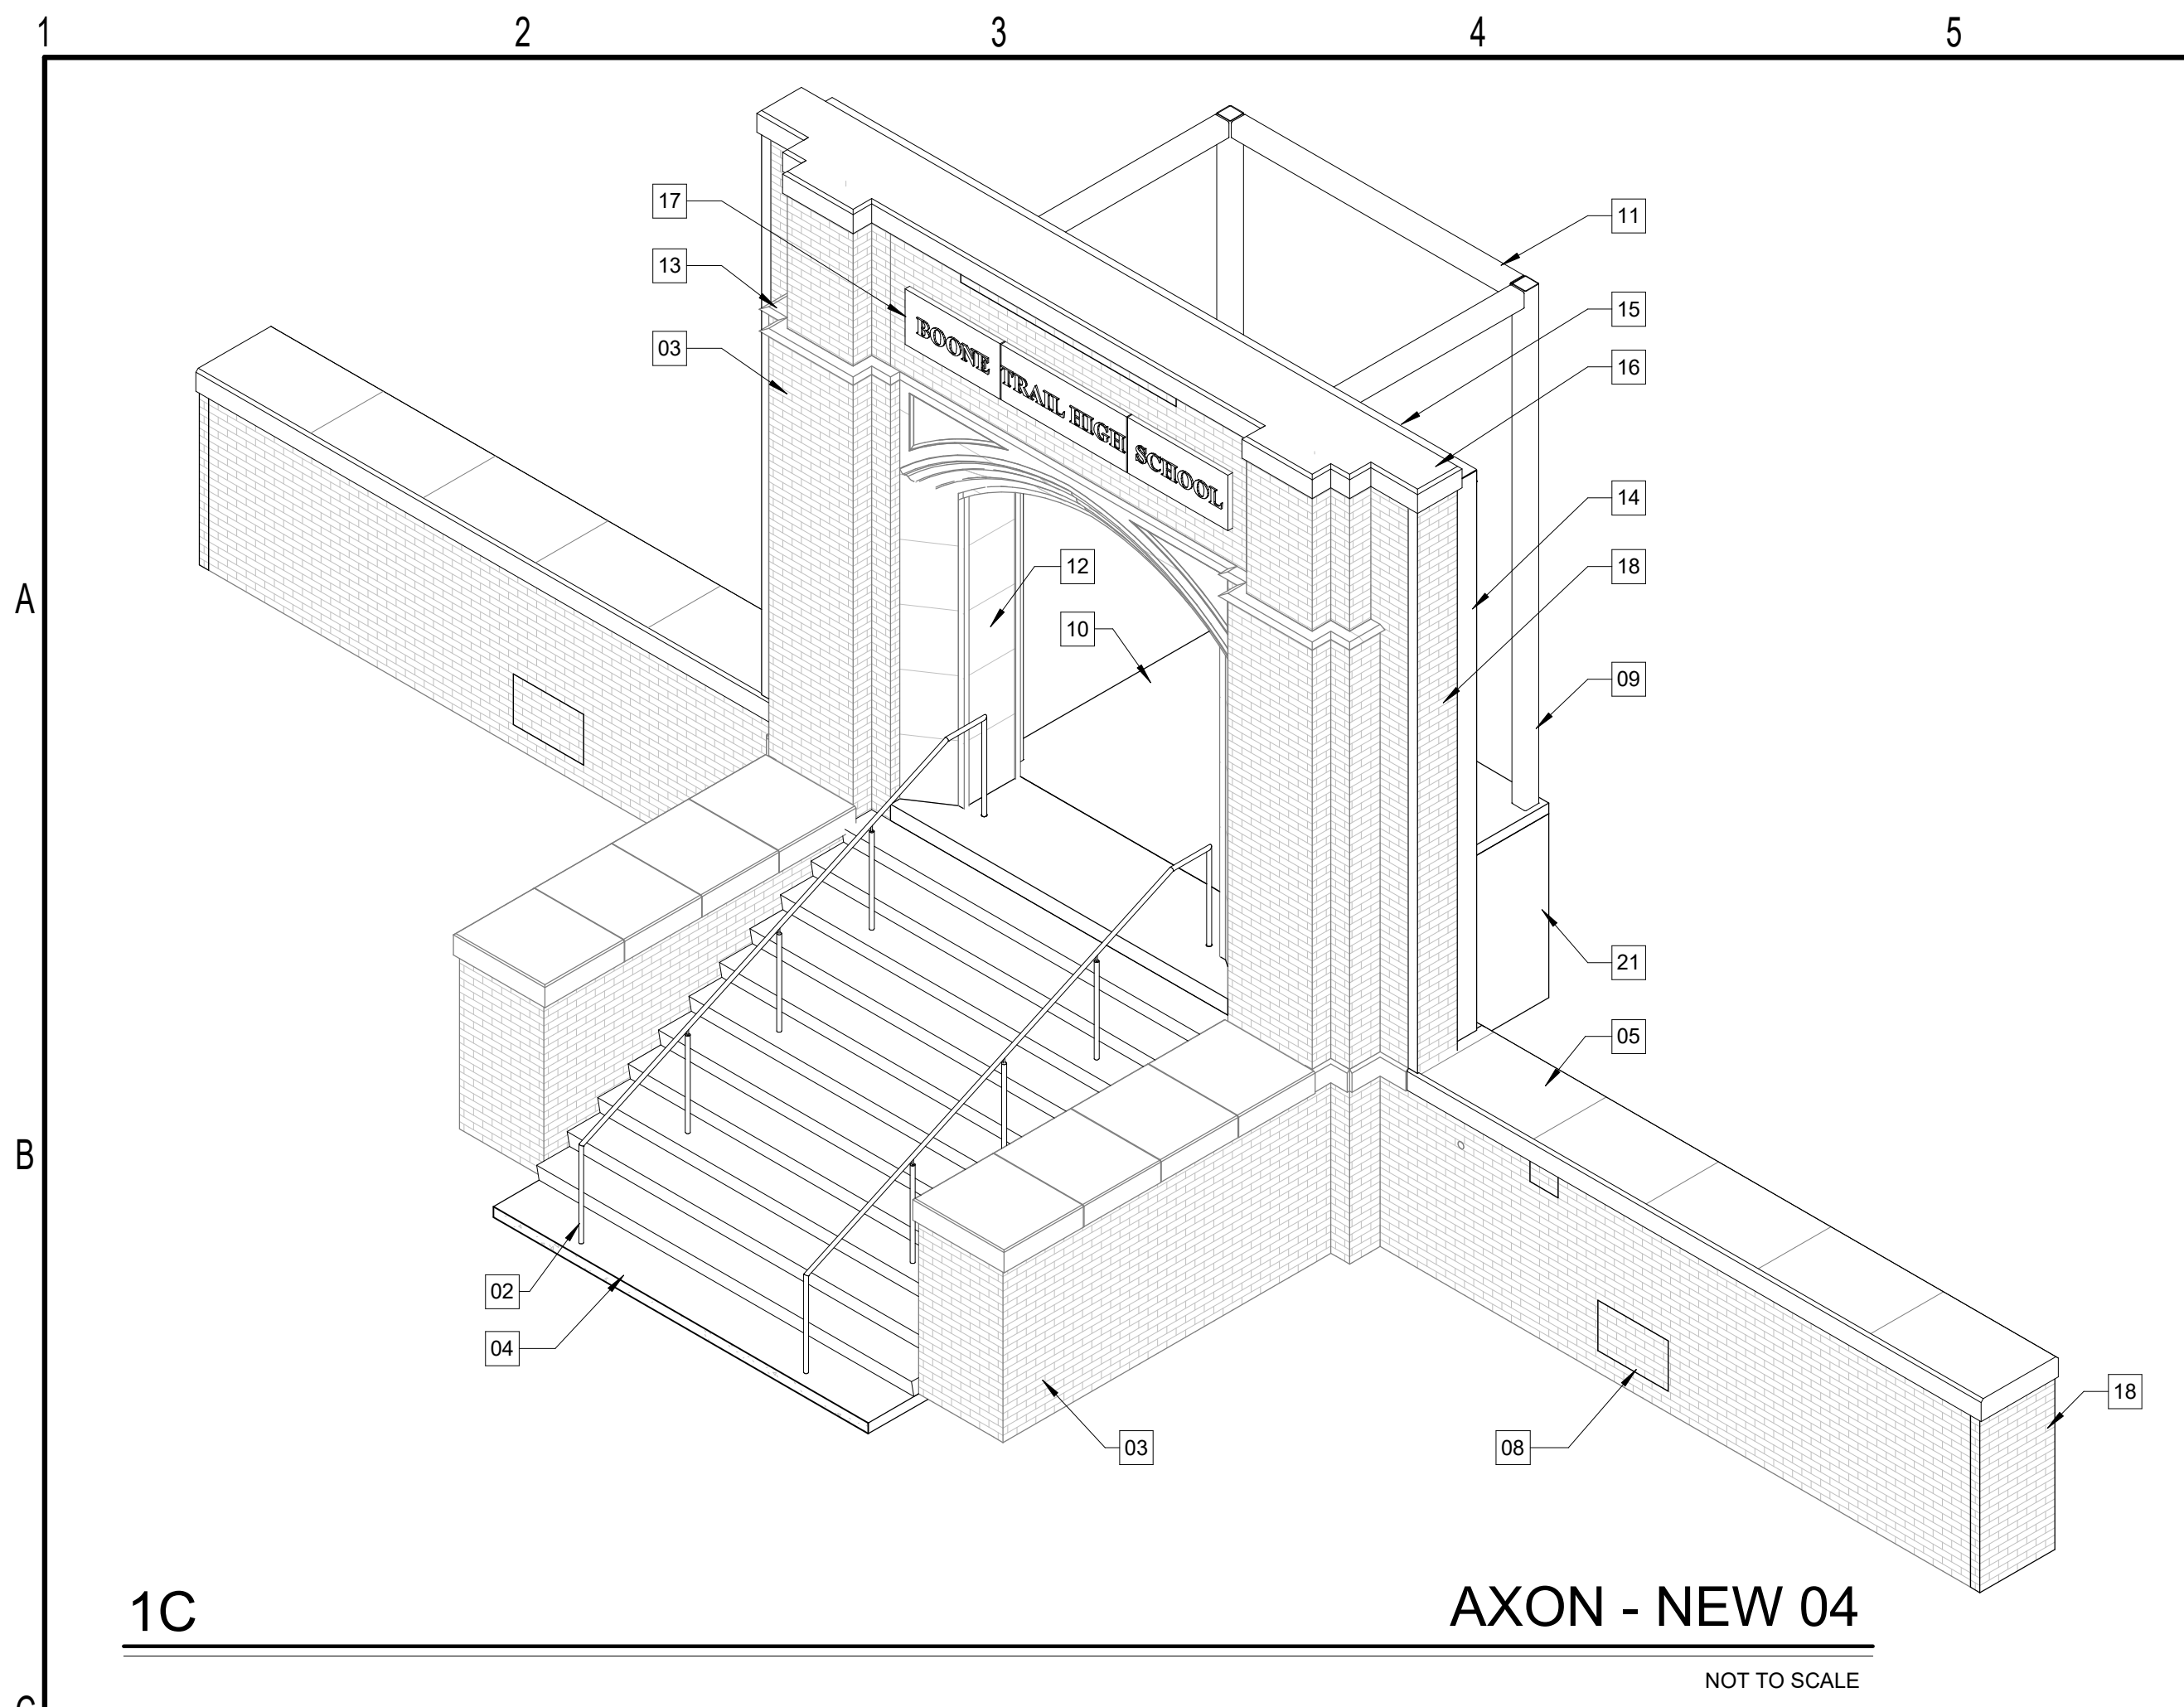
CONSTRUCTION DOCUMENTS

Revisions		
No.	Description	Date

date: 08/23/2024
commission: Z3-670

sheet title: **DETAILS**

sheet no.: **A6.04**



- KEYED NOTES**
- 01 EXISTING STONE LEDGE CAP. REMOVE, CLEAN AND RESET IN ORIGINAL LOCATION ON MASONRY WALLS
 - 02 NEW 1 1/2" DIA STEEL PIPE HANDRAIL WITH INTEGRATED LIGHTING PER E100 SHEET. PAINT WITH HIGH PERFORMANCE PAINT, COLOR TBD
 - 03 EXISTING BRICK MASONRY WALL TO REMAIN. SEE REPAIR/PRESERVATION SHEETS FOR SCOPE
 - 04 NEW MONOLITHIC CONCRETE STAIR
 - 05 NEW CONCRETE LEDGE CAP WITH CHAMFERED EDGE (EDGE PROFILE TO MATCH EXISTING). MATCH COLOR TONE WITH EXISTING LESTONE STRUCTURE. PROVIDE MOCKUP SAMPLES FOR OWNER REVIEW AND APPROVAL
 - 06 DASHED LINE DENOTES CENTERLINE
 - 07 MODIFY EXISTING GRADE TO SLOPE UP TO LANDING. MAXIMUM DISTANCE BETWEEN LANDING AND GRADE NOT TO EXCEED 30". COORDINATE SITE WORK WITH OWNER. SITE WORK NOT IN DRAWING SCOPE
 - 08 INFILL EXISTING MASONRY OPENING WITH SALVAGED BRICK. COORDINATE SALVAGE STOCK WITH OWNER. MATCH MORTAR COLOR AND COMPOSITION WITH EXISTING. MATCH BOND LAYOUT FOR SEAMLESS TRANSITION AND INFILL
 - 09 NEW HSS 6X6X1/4 STEEL COLUMN. PAINT WITH HIGH PERFORMANCE EXTERIOR PAINT. BASIS OF DESIGN:
PRIMER
SHERWIN WILLIAMS MACROPOXY 646 EPOXY PRIMER (2 COATS)
FINISH PAINT
SHERWIN WILLIAMS INDUSTRIAL ENAMEL ALKYD (2 COATS)
 - 10 NEW 4" CONCRETE SLAB-ON-GRADE
 - 11 NEW HSS 6X6X1/4 STEEL BEAM. PAINT WITH HIGH PERFORMANCE EXTERIOR PAINT, PER CL BOD
 - 12 EXISTING LIMESTONE ARCHED ENTRY. PROTECT IN PLACE. SEE REPAIR/PRESERVATION SHEETS FOR CLEANING AND REPAIR PROCEDURES
 - 13 EXISTING DECORATIVE LIMESTONE BANDING TO REMAIN. PROTECT AND REPAIR PER REPAIR/PRESERVATION SHEETS
 - 14 NEW METAL PANEL EXTERIOR FINISH. BASIS OF DESIGN:
ATAS METAFOR MFP120, SMOOTH FINISH, INSTALL VERTICALLY. PROVIDE FULL RANGE OF COLOR OPTIONS FOR ARCHITECT/OWNER SELECTION
 - 15 NEW METAL PARAPET CAP PER METAL PANEL SUPPLIER.
 - 16 NEW CONCRETE PARAPET CAP. MATCH LEDGE CAP
 - 17 SALVAGED CONCRETE BUILDING SIGNAGE. INSET IN EXISTING MASONRY WALL PER SECTION DETAILS
 - 18 NEW BRICK MASONRY END WALL. CONSTRUCT WITH SALVAGED MASONRY. COORDINATE WITH OWNER FOR STOCK. WEAVE NEW BRICK INTO EXISTING TO CREATE SEAMLESS CORNER
 - 19 NEW BRICK WALL. IF SALVAGE STOCK IS NOT AVAILABLE, USE LIKE KIND NEW BRICK. PROVIDE SIMILAR MORTAR JOINT COMPOSITION AND WIDTH TO MAINTAIN CONSISTENT EXTERIOR APPEARANCE. PROVIDE SAMPLES PRIOR TO INSTALLATION FOR OWNER APPROVAL
 - 20 BRASS METAL TRIM CLOSURE PLATE. FORM TO MATCH ARCH OF EXISTING LIMESTONE ENTRY. COLOR TO MATCH METAL PANEL
 - 21 NEW REINFORCED CMU BEARING WALL AT LANDING
 - 22 NEW MASONRY INFILL. USE SALVAGED BRICK TO MATCH EXISTING

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AXON DIAGRAMS

sheet no.:
A9.01



1C

CONCEPTUAL RENDERING 04

NOT TO SCALE



6C

CONCEPTUAL RENDERING 02

NOT TO SCALE



1F

CONCEPTUAL RENDERING 03

NOT TO SCALE



6F

CONCEPTUAL RENDERING 01

NOT TO SCALE

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A9.02